#### SALISBURY PLANNING BOARD SITE PLAN REVIEW FILING CHECKLIST

#### Applicants encouraged to meet with planning department for review of application prior to filing. Applications will not be stamped in at the Town Clerk's office for the Planning Board, until the Planning Department determines that the following items are included with the application:

- 1. Application must be filled out completely and correctly. (Map and Parcel must be included. Can be found in the Assessor's Office.) Attachment 1
- 2. <u>Planning Dept. reviews application & plans for completeness prior to receiving fees and copies</u> for the Board
- 3. A complete REQUIREMENTS AND WAIVER REQUEST FORM must be submitted along with copies of site plan filings: Attachment 2 The waiver request goes to the planning board as a preliminary SPR to only decide on waivers. After decision is made, applicant then submits 8 copies of plans, along with fees and application, and can be stamped in by Town Clerk.
- 4. Abutters List Request form must be completed at the Assessor's Office (if applicable-check with planning dept.) (\$15-checks payable to the Town of Salisbury).
- 5. Treasurer's Office signature to ensure all Taxes are paid up to date on the property in question and any applicable betterments are paid in full: Attachment 3
- 6. A complete site plan submittal checklist **must** be submitted along with copies of site plans: Attachment 4
- 7. When plans ready to be stamped in by Town Clerk:
  - a. Site Plan Review Application & Review Fee Checks payable to the Town of Salisbury.
  - b. Registered Plan drawn to scale and in conformance with Section II.B.1 of the site plan review requirements. (8 Copies)

Planning Department

Town Clerk

#### \*\*\* Note to Applicants \*\*\*

- □ Applicants shall bear the cost of advertising the legal notices in the Newburyport Daily News, and will be directly billed by that publication.
- Planning Board will schedule a Public Hearing within 30 Days of complete submission. For major projects, they will have 60 Days from the date the public hearing was opened to reach a decision. For minor projects, the board has 45 days from the date the application was stamped in by the Town Clerk to reach a decision.
- □ All conditions must be met and required changes made to the plan, then submitted to the Planning Board for review before a building permit will be assigned.

#### Attachment 1

#### <u>TOWN OF SALISBURY</u> <u>APPLICATION FOR SITE PLAN REVIEW</u>

#### A REGISTERED SITE PLAN <u>MUST</u> BE FILED WITH THIS APPLICATION FORM

Date 03/17/23

Applicant's Name Our Neighbors' Table

Applicant's Address <u>114 Bridge Road, Salisbury MA 01952</u>

Telephone # & Fax # \_978-388-1907

E-mail Address lyndsey@ourneighborstable.org

Application is hereby made for Site Plan Review. This application is for property located at <u>114 Bridge Road</u>, Salisbury, Massachusetts.

Tax Map #<u>14</u> Lot # <u>10</u>

- Owner of Property: <u>Our Neighbors' Table</u>
   Owner's Address: <u>114 Bridge Road, Salisbury MA</u>
- 2. Zoning District: <u>Commercial C</u>
- 3. Lot Size: <u>3.76 Acres</u>
- 4. Existing Use: <u>B-Business and S-2 Storage</u>
- 5. Proposed Use: <u>B-Business and S-2 Storage</u>
- 6. Description of Proposed Work: <u>Renovation of existing building for use as office space and</u>

storage for Our Neighbors' Table Seacoast Food Hub. A small addition on the North side will

accommodate receiving at a new depressed 3bay loading dock.

- 7. Square Footage of All Proposed Work: <u>New Space: 400sf at loading dock, Renovated Interior Space: approximately</u> <u>6,000sf</u>
- 8. Other Permits Required and Status of Applications: <u>Building Permit—submit for initial</u>

Review in March 2023

- 9. Site Plan Waivers Requested: Stormwater Drainage Calculations, Certified Landscape Plan and Full Traffic Analysis
- 10. Reason for Waiver Request <u>Drainage and Landscape to remain as is, and Applicant is submitting a Traffic Memo</u> Showing no discernible impact

Signature of Applicant

Signature of Owner

#### Planning Board

#### **REQUIREMENTS AND WAIVER REQUEST FORM**

Applicant Our Neighbors Table Map and Parcel # 14-10

Property Owner Our Neighbors Table Project Address 114 Bridge Road

Plan	Requirements	Included in Application	Requesting Waiver
Α.	Plans drawn by registered professional	<u>X</u>	
В.	Existing site conditions:		
υ.	1. All waterbodies	X	
	2. Wetland and Boundaries	<u>X</u>	
	3. Topography	X	
	4. Vegetation types	<u>X</u>	
	5. Other natural features	X	
C.	Location of:		
υ.	1. Proposed landscaping		X
	2. Existing landscaping and open space	• X	
D.	Use Plan indicating locations of		
	1. Proposed building and additions	<u>X</u>	
	2. Parking	<u>X</u>	
	3. Service and loading areas	<u>X</u>	
	4. Curbing and driveway locations	<u>X</u>	
	5. Trash and receptacles or dumpsters	<u>X</u>	
	6. Lighting	<u>X</u>	
	7. Other site alterations	<u>X</u>	
E.	Architectural plans of all proposed buildings		
	1. Floor plans	<u>X</u>	
	2. Elevation plans	<u>X</u>	
F.	Utility Plans showing		
••	1. Water and sewer connection	X	
	2. Stormwater Drainage Plan		X
G.	Luminairo Plan showing		
в.	Luminaire Plan showing 1. Foot Candles	X	2000

X

Full Traffic Study (Providing Traffic Memo Herein)

**Attachment 3** 

#### SITE PLAN APPLICATION TAX AND BETTERMENT PAYMENT CERTIFICATION

Date 2 24 73

Map 14 Parcel 10

Owner's Name: Our Neighbors Table

Property Address: 114 Bridge Road Salisbury, MA

I, Jura Hung, In, certify that all taxes and applicable betterment's have been paid in full for the

property located at Map 14 Parcel 10. The next billing date is EVempt.

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#### Attachment 4

#### SITE PLAN REVIEW SUBMITTAL CHECKLIST

Before any Site Plan Review application can be filed at the town clerk's office, the following departments must receive the specified information and sign below that the information has been received. Departments have 14 days within which they may approve, disapprove, or comment on the proposed plan.

<b>Board of Health</b> (1 Set of Plans & application) Received By:	Date:			
Fire Department         (1 Set of Plans & application)       Received By:	Date:			
<b>Department of Public Works</b> (3 Sets of Plans & application) Received By:	Date:			
Building Department (1 Set of Plans & application) Received By:	Date:			
Conservation Commission (1 Set of Plans & application) Received By:	Date:			
Police Department (1 Set of Plans & application) Received By:	Date:			
Assessor's Department (1 Set of Plans & application) Received By:	Date:			
Planning Department         (8 Set of Plans & application) Received By:	Date:			
<b>Design Review Committee (if Beach Overlay District App</b> (3 Sets of Plans & application to Planning Department) Received By:	Dites)Date:			
Housing Partnership Committee (if Inclusionary Zoning (1 Set of Plans & application to Town Clerk)				
Received By:           Attachments(17 copies of each—updated in bold):	Date:			
<ol> <li>MTC Cover Letter and Narrative 2/21/23</li> <li>MTC Waiver Request Letter 2/21/23</li> <li>Millenium Engineering Response to Town of Salisbury Comments 3/16/23</li> <li>Floodplain Certification dated 01/22/22</li> <li>114 Bridge Road/Our Neighbors' Table Deed</li> <li>Bayside Engineering Traffic Memo dated 11/04/2022</li> <li>Millenium Engineering Drawings(updated) dated 3/16/2023: Existing Conditions Plan, Site Plan, Details</li> <li>Visible Light, Inc Photometric Drawing dated 2/20/2023</li> <li>Merrimack Design Architects Drawings dated 2/13/2023: Cover Sheet, D1-1, D1-2, A1-1, A1-2, A1-3, A2-1, A2-2</li> </ol>				



30 Green Street Newburyport, MA 01950 Phone 978.463.7700 Fax 978.463.7747

www.mtclawyers.com

February 21, 2023

**By Email** 

Marty Doggett, Chair Salisbury Planning Board 5 Beach Road Salisbury, Massachusetts 01952

RE: <u>Major Site Plan Review</u> <u>114 Bridge Road (the "Property")</u> <u>Assessors Map 14 Lots 10</u>

Dear Chair and Members of the Board:

Reference is made to the above captioned matter. In that connection this firm represents Our Neighbors' Table (the "Applicant") for approval of a Major Site Plan Review in accordance with Article XVIII, Section 300-109-120 of the Salisbury Zoning Bylaw ("SZB") and accompanying regulations of the Planning Board governing Site Plan Review.

The Property is located in the Commercial ("C") zoning district and currently is classified under the table of uses as B-Business and S-2 Storage and will continue to be classified as such after the renovations to the building. The Applicant proposes to renovate the interior of the building and construct a small 8 feet x 51 feet addition on the north side of the building to accommodate a new depressed loading dock in that area. Additionally, there is a modest relocation of the westerly wall of the patio area on the north side of the structure in order to accommodate a generator and transformer for the upgraded electrical service to the building.

The Applicant proposes to operate a regional seacoast food hub and market similar to the Applicant's facility in Amesbury. As you are aware, food insecurity is an epidemic problem in northeast Massachusetts and the Applicant aims to service those families which attempt to meet their food needs by alternative means. One of

Millis Office 730 Main Street, Suite 1F Millis, MA 02054 Phone/Fax 508.376.8400

New Bedford Office 227 Union Street, Suite 606 New Bedford, MA 02740 the reasons the Applicant purchased this property is due to its location and prior permitting history which had been completed as recently as 2014<sup>1</sup>. The Applicant is proposing no changes to the exterior of the building but for that noted above. Additionally, there are no changes proposed to the parking layout and traffic flow on the Property but for the delineations on the pavement related to handicap access and walkways. Finally, the Applicant proposes no changes to the previously approved Site Plan landscaping.

As a result, the Applicant has submitted a request for three waivers, Stormwater Analysis, Certified Landscape Plan and Full Traffic Impact Analysis. Said waiver request is attached hereto.

In accordance with the Board's Regulations, I submit the following:

- Site Plan: the Site Plan attached hereto by Millennium Engineering, Inc. includes the location and boundaries of the Property, the structures, signage, pedestrian access and parking and internal vehicular access, the location of parking, there is no public access as this is a private property, lighting, topography, and water, waste and stormwater utilities.
- 2. Project Narratives:
  - a. Surface and ground water pollution: A waiver has been requested.
  - b. Soils: A waiver has been requested as part of the storm water analysis.
  - c. <u>Environmental and Community Impact Analysis</u>: The building and use are existing and recently permitted on site. There are no changes to impervious surfaces. There is no discernible change to the landscaping on the Property. The ingress and egress and traffic flow on site remains unchanged. From the bricks and mortar of the Property there will be no negative environmental or community impact. However, there will be a significant benefit to the community from the change of operations on site. The most recent use of the site was a hazardous waste clean-up operation. The risk of those trucks and that material on site will no longer impact the community. The new operations on site,

<sup>&</sup>lt;sup>1</sup> Please note, the Applicant is aware of the one outstanding item from prior Site Plan approval which does not go to the physical characteristics of the site and which is being addressed with the Town.

on the other hand will greatly benefit the community, namely the location of the regional food hub for the Applicant. The centralized location of the operations of the Applicant will greatly benefit the residents of Salisbury and the residents of the surrounding community providing a more direct way to address food insecurity in the region. The proposed project will have a net positive impact on the environment and benefits of the community.

d. <u>Traffic Impacts</u>: The Applicant seeks a waiver for a formal submission of a full traffic impact analysis. However, the Applicant has provided a Traffic Memorandum which states "Compared to the existing office building, the proposed project would have less of an impact during the weekday morning peak hour and a comparable impact during the weekday evening peak hour compared to the former office use." Ultimately, there is no negative or adverse pedestrian and vehicular impact from the Applicant's use on the Property.

- e. Architectural Style: The Applicant is not proposing any changes to the existing structure.
- <u>f.</u> <u>Other Permits</u>: No other permits are required.

We look forward to presenting the plan to the Board.

Respectfully submitted, Our Neighbors' Table By its Attorney, Lisa L. Mead

cc: Client

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30 Green Street Newburyport, MA 01950 Phone 978.463.7700 Fax 978.463.7747

www.mtclawyers.com

February 21, 2023

<u>By Email</u>

Marty Doggett, Chair Salisbury Planning Board 5 Beach Road Salisbury, Massachusetts 01952

RE: <u>Major Site Plan Review</u> <u>Waiver Request</u> <u>114 Bridge Road (the "Property")</u> <u>Assessors Map 14 and Lot 10</u>

Dear Chair and Members of the Board:

Reference is made to the above captioned matter. In that connection this firm represents Our Neighbors' Table (the "Applicant") for approval of a Major Site Plan Review in accordance with Article XVIII, Section 300-109-120 of the Salisbury Zoning Bylaw ("SZB") and accompanying regulations of the Planning Board governing Site Plan Review. This letter shall serve as a formal request for Wavers in accordance with section 300-112(D) of the SZB.

**Request:** Landscape Plan Certified by Landscape Architect: As you are aware, the Property has been previously developed and has received Major Site Plan approval from this Board as recently as 2014 and has achieved a full certificate of compliance but for an unrelated issue as to an easement for the Property. The proposed work will not be impacting any of the previous approved landscaping improvements on the site but for one. That is, on the north side of the building there is a patio which will be slightly reduced in size to accommodate a generator and transformer for the updated electrical service.. This change will not impact the over all landscaping to the extent that a new certified landscape plan should be submitted. Further, while there is proposed to be a new loading dock area on the rear northwest corner of the

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New Bedford Office

227 Union Street, Suite 606 New Bedford, MA 02740 building this does not impact the landscape plan to any great extent. Both the transformer change and the loading area change will not have a discernable impact on the approved landscaping of the Property such that it justifies the creation of a new landscape plan. The provision of a certified landscaping plan is not necessary to serve the public interest and no public benefit would result if one were required.

**Request:** Traffic Impacts Report: The Applicant requests a waiver from providing a full traffic report. The Applicant is providing a Traffic Memo that notes a slight reduction in overall trip generation. Please note, while the use of the Property is changing to some extent, the changes do not justify a full Traffic Impact Report. The parking layout and circulation are not changing to any great extent and the size of the building likewise has a nominal increase in square footage. As a result, the Applicant is providing a traffic memorandum to address the changes which are occurring. The Site Plans include all necessary pedestrian access and vehicular access to and from the site. There is no change to the public infrastructure and no sidewalks exist on Bridge Road. The provision of a formal traffic study is not necessary to serve the public interest given the proposed use and negligible changes to the site.

**Request:** Provision of a Stormwater Analysis Memorandum: The Applicant is not making changes to the Property which would impact or change the current stormwater flow or treatment on site. There is no increase in impervious surface and therefore no analysis is required. While there is a grade change at the new loading dock, that area is already impervious and a trench drain will be added as set forth on the plans. No public benefit will be served by requiring a stormwater analysis given that there is no new impervious surface proposed.

Respectfully submitted, Our Neighbors' Table By its Attorney

cc: Client

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### MILLENNIUM ENGINEERING, INC. Land Surveyors and Civil Engineers

March 16, 2023

Salisbury Department of Community Development Town Hall 5 Beach Road Salisbury, MA. 01952

Attn: Lisa Pearson, Planning Dept.

Re: 114 Bridge Road Departmental Review Comments, dated March 9, 2023

Ms. Pearson,

The following provides our response to peer review comments referenced above. We have included the departmental review comments and our response to facilitate the Board's review.

	Comment / Response
Application	
Comment 2:	Abutters list is needed.
Response:	The abutters list will be provided as part of the official filing.
Comment 3:	Copy of Current deed for parcels is needed.
Response:	A copy of the current deed will be provided as part of the official filing.
Comment 4:	The applicant will have to work with the Town of Salisbury to get the proper easements in place to comply with the previous Site Plan Approval that is currently still active.
Response:	The applicant will work with the Town of Salisbury regarding the easement.
Comment 5: Response:	Please have existing conditions plan signed and stamped by a Professional Land Surveyor. The plan has been stamped by a Professional Land Surveyor.
Response: Comment 6:	The plan has been stamped by a Professional Land Surveyor.Additional grading is needed west of the dumpster.
Response:	Additional topography has been provided.
Site Plan (C	2-3):
Comment 7:	The proposed dewatering area would feed water south through the swale and into the basin. If the dirt bag were to fail for some reason there would be not protection for the silt laden water. Please move the silt sock so the proposed dewatering area is within the

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into the groundwater table. This will lead to constant dewatering and the dirt bag will be under constant pressure. For this reason, comment #5 is very important. Please make sure contract that additional dirt bags on site.         Response:       The contractor that will be installing the trench and loading dock has many years of experience working with construction within water. Additional erosion controls have been added around the dewatering area and additional dirt bags can be on site in the ever the dirt bag needs to be replaced.         Comment 9:       The proposed depressed loading dock shows a bottom elevation of 6.2 and there will be a trench drain which will feed into a pump station. Based on the test pit information shown on Sheet -3, the ESHWT is at EL 8.3. This means that at certain times of the year that concrete around the drain will be within the groundwater. How will the concrete be affected by the groundwater?         Response:       Concrete is commonly placed within groundwater either for foundations or footings. There is no concern over the concrete being within groundwater during certain times of the year.         10:       If the loading dock were to be affected by a flood, where would all the water go? Detail: The pump station would dump the water out through the riprap and based on the grades west of the dumpster to know what the grades look like back there. So, the water will either go west towards the wetland or east back to the pavement and back into the loading dock.         Response:       The area of the loading dock is located outside of the 100-yr floodplain. The flow from the pump station would discharge to the west of the building and ultimately flow to the welland located off-site. Additional grades have been provided.         Comment	Response:	Additional erosion controls have been provided around the dewatering area.
<ul> <li>Response: The contractor that will be installing the trench and loading dock has many years of experience working with construction within water. Additional erosion controls have been added around the dewatering area and additional dirt bags can be on site in the ever the dirt bag needs to be replaced.</li> <li>Comment 9: The proposed depressed loading dock shows a bottom elevation of 6.2 and there will be a trench drain which will feed into a pump station. Based on the test pit information shown on Sheet -3, the ESHWT is at EL 8.3. This means that at certain times of the year that concrete around the drain will be within the groundwater. How will the concrete be affected by the groundwater?</li> <li>Response: Concrete is commonly placed within groundwater either for foundations or footings. There is no concern over the concrete being within groundwater during certain times of the year.</li> <li>If the loading dock were to be affected by a flood, where would all the water go? Detail: The pump station would dump the water out through the riprap and based on the grades it would follow the arrows shown above. It would then pool behind the dumpster. It won's continue north due to the grades going up in elevation and we don't have enough grades west of the dumpster to know what the grades look like back there. So, the water will either go west towards the wetland or east back to the pavement and back into the loading dock.</li> <li>Response: The area of the loading dock is located outside of the 100-yr floodplain. The flow from the pump station would discharge to the west of the building and ultimately flow to the wetland located off-site. Additional grades have been provided.</li> <li>Comment 11: require a stornwater report to ensure no adverse impacts.</li> <li>Response: We disagree that the installation of the pump station is no up of a change that we will require a stornwater report to ensure no adverse impacts.</li> <li>Response: We disagree that the installation of the</li></ul>	Comment 8:	into the groundwater table. This will lead to constant dewatering and the dirt bag will be under constant pressure. For this reason, comment #5 is very important. Please make
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12: Besnonse:	Site Lightin	g Layout Plan:
Pasnonsa:	Comment 12:	No Comments.
The response required.	Response:	No response required.

Lanuscape	1 1411	
Comment	A waiver has been requested from the Landscape Plan based on the fact that the	
13:	landscaping will remain the same. The Planning Board may require a landscape plan.	

Massachusetts:	62 Elm Street - Salisbury – MA – 01952
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 978 - 499 - 0029

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 603 - 772 - 0689

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Response:	No response required.	
Stormwate	r Report	
Comment 14:	The applicant has requested a waiver from providing a stormwater report. The applicant is proposing to add a trench at the bottom of the proposed depressed loading dock. That trench will feed into a pump station that will regulate the stormwater coming out. Based on concerns in comments #9, #10, and #11, as well as the MS4 State permit requirement for a stormwater report, the Planning Department would request a stormwater report be submitted with the Site Plan Review Submission. If the applicant would like to get a waiver, they would be advised to make that request to the Planning Board prior to making their submission. This may delay your Site Plan Review submission date if the Planning Board requires a stormwater report.	
Response:		
Traffic Imp	oact Analysis	
Comment 15:	The Police Chief provided a comment on the waiver request for the Traffic Impact Study. The Police Chief has requested that a traffic impact study be completed so that we can properly understand the impact on Bridge Road and how to properly mitigate it. This will need to be reviewed by a Traffic Engineer to determine whether a full Traffic Impact Study is needed.	
Response:	This item was discussed with the Assistant Planner and it was determined that the Traffic Memo that was provided will be reviewed to determine whether a Traffic Impact Study would be necessary.	

We trust this response letter provides the necessary information for the Board's consideration of the request for completeness. If you have any questions or comments, please feel free to contact our office at your convenience.

Sincerely,

Millennium Engineering, Inc.

James Melvin, P.E. Project Manager

w/ Attachments

62 Elm Street - Salisbury – MA – 01952 13 Hampton Road – Exeter – NH – 03833 www.Mei-MA.com

Phone: 978 - 463 - 8980 Fax: 978 - 499 - 0029 603 - 778 - 0528 603 - 772 - 0689 www.Mei-NH.com

#### DEPARTMENT OF HOMELAND SECURITY Federal Emergency Management Agency STANDARD FLOOD HAZARD DETERMINATION FORM (SFHDF)

SECTION I - LOAN INFORMATION						
1. LENDER/SERVICER NAME AND ADDRESS 2. COLLATERAL DESCRIPTION (Building/Mobile Home/Property) (See instructions for						
Newburyport Five Cents Saving	s	more information.) 114 BRIDGE RD				
Bank 63 State St		SALISBURY, MA 01952				
Newburyport, MA 01950		Borrower: Our	n Ne	ighbors' Table	, Inc, or Nominee	
<u>Branch</u> : 63 State Street <u>Requested By</u> : Shelly Prentis	S					
3. LENDER/SERVICER ID #	4 1 0 4	N IDENTIFIER			DD INSURANCE REQUIRED	
90251	4. LUAI			5. AMOUNT OF FLOC	DD INSURANCE REQUIRED	
		SECTION II				
A. NATIONAL FLOOD INSURANCE PROGRAM			ION			
1. NFIP Community Name	2.	County(ies)		3. State	4. NFIP Community Number	
SALISBURY, TOWN OF		SSEX		MA	250103	
B. NATIONAL FLOOD INSURANCE PROGRAM			1			
<ol> <li>NFIP Map Number or Community-Panel Numb (Community name, if not the same as "A")</li> </ol>		NFIP Map Panel fective/Revised Date	3.	s there a Letter of Map C	Change (LOMC)?	
25009C 0128F		07/03/12	x	NO YES (if yes, and LOM date and case no. bel	IC date/no. is available, enter ow).	
4. Flood Zone	5.	No NFIP Map	]			
x500*			Da	te 03/28/13 Ca	ase No. 13-01-1272A	
C. FEDERAL FLOOD INSURANCE AVAILABIL	ITY (Chec	ck all that apply.)				
<ol> <li>Tederal Flood Insurance is available (community participates in the NFIP). Tederal Flood Insurance is not available (community does not participate in the NFIP).</li> <li>Federal Flood Insurance is not available (community does not participate in the NFIP).</li> <li>Building/Mobile Home is in a Coastal Barrier Resources Area (CBRA) or Otherwise Protected Area (OPA). Federal Flood Insurance may not be available.</li> </ol>						
CBRA/OPA Designation Date:	_					
IS BUILDING/MOBILE HOME IN SPECIAL FLC If yes, flood insurance is required by the Flood D If no, flood insurance is not required by the Flood removed.	saster Pro	otection Act of 1973.				
This determination is based on examining the NF other information needed to locate the building/m			anag	ement Agency revisions	to it, and any	
E. COMMENTS (Optional)						
* The subject property IS PARTIALLY WITHIN a Special Flood Hazard Area. The existing STRUCTURE, however, is not affected and is not in the floodplain.						
THIS FLOOD DETERMINATION IS PROVIDED TO THE LENDER PURSUANT TO THE FLOOD DISASTER PROTECTION ACT. IT SHOULD NOT BE USED FOR ANY OTHER PURPOSE.						
tooo certificanou						
F. PREPARER'S INFORMATION						
NAME, ADDRESS, TELEPHONE NUMBER (If other than Lender) DATE OF DETERMINATION						
CoreLogic Flood Services CoreLogic (01/25/22 at 09:35 AM CST						
1825A Kramer Lane Austin, TX 78758 1-800-447-1772		This fload new information we made is p proch lith with the efficace and endates and conflicacion requirements of Areth is prime and the second second second Are of 1975		FloodCert #:		
	7702 / М	FCSB-5878 Produce	don	*** LIFE-OF-L( 01/25/22 at 09:35 AM CST	OAN *** SFHDF - Form Page 1 of 1	
1 Emile Fortili 000-0-32 (00/10) 220181	<i>। וסב  </i> ואו		ստու	1123122 at 03.33 AW 631	GENDE - FORM Page 1 OF 1	

#### **QUITCLAIM DEED**



BRUDAC, LLC, a Massachusetts Limited Liability Company with a principal place of business at 79 Parker Street, Newburyport, MA 01950

For consideration paid, and in full consideration of Three Million Four Hundred Thousand and no/100 (U.S. \$3,400,000.00) Dollars,

Grant to OUR NEIGHBORS' TABLE, INC., a Massachusetts nonprofit corporation with an address of 194 Main Street, P.O. Box 592, Amesbury, MA 01913

with **QUITCLAIM COVENANTS** the following property in Essex County, Massachusetts.

PROPERTY: 108 BRIDGE ROAD, SALISBURY, MA

MASSACHUSETTS EXCISE TAX Southern Essex District ROD Date: 03/21/2022 03:26 PM ID: 1518688 Doc# 20220321004480 Fee: \$15,504.00 Cons: \$3,400,000.00

A certain parcel of land with the buildings thereon situate on the Westerly side of Bridge Road, in the Town of Salisbury, Essex County, Massachusetts described as follows:

Beginning at an iron stake where the state highway known as Bridge Road, and the land of Hodgdon, formerly of George Liverey, and the land of the grantors meet and running in a Southerly direction by said state highway, known as Bridge Road, to an iron stake and remaining land of the grantors one hundred (100) feet; thence turning and running in a Westerly direction by remaining land of the grantors to an iron post and land of the Boston and Main Railroad about three hundred thirty (330) feet; thence turning and running in a Northerly direction by land of the Boston and Maine Railroad to an iron stake and land of Hodgdon, formerly of George Liverey, ninety-two (92) feet; thence turning and running in an Easterly direction by land of Hodgdon, formerly of George Liverey, to an iron stake and Bridge Road about three hundred and thirty-four (334) feet to the point of beginning.

#### PROPERTY: 114 BRIDGE ROAD, SALISBURY MA

The land in the Town of Salisbury with the buildings thereon, containing three acres and one hundred forty seven rods, being the same more or less, bounded and described as follows:

EASTERLY:	by State Highway leading from Newburyport to Salisbury Square;
NORTHERLY:	by land now or formerly of George Liverey, thence measuring
	twenty rods and six links;
WESTERLY:	by the Boston and Maine Railroad; and
SOUTHERLY:	by land now or formerly of John Dow.

Also see plan recorded on November 15, 2005 at the Essex South District Registry of Deeds in Plan book 393, Plan 12.

The above-described premise are conveyed subject to and together with the benefit of the following:

- 1. Rights reserved in a deed from George A. Dow to Elizabeth Houle dated January 29, 1902 and recorded with the Essex South District Registry of Deeds in Book 1664, Page 389.
- 2. Terms of a Special permit issued by the Salisbury Zoning Board of Appeals, a notice of which is recorded with the said Registry of Deeds in Book 19782, Page 121.
- 3. Matters set forth in that certain Affidavit from David A. Cowie dated March 31, 2014 and recorded with the said Registry of Deeds in Book 33207, Page 535.

For title, see Foreclosure Deed recorded in Book 31727, Page 437.

[SIGNATURE PAGES TO FOLLOW]

Witness my hand and seal this  $2^{1-4}$  day of March, 2022.

BRUDAC, LLC,

and A. Inic

By: David A. Cowie, Manager

#### COMMONWEALTH OF MASSACHUSETTS

<u>Esses</u>, ss.

On this 21% day of March, 2022, before me, the undersigned notary public, personally appeared **David A. Cowie, Manager of BRUDAC, LLC,** and proved to me through satisfactory evidence of identification, which was 2muggs Lucasse, to be the person whose name is signed on the preceding or attached document, and acknowledged to me that he signed it voluntarily for stated purpose as the free act and deed of BRUDAC, LLC.

Notary Public My commission expires:





#### **MEMORANDUM**

TO: Lyndsey Haight Our Neighbors' Table

FROM: Kenneth P. Cram, P.E.

DATE: November 4, 2022 RE: Proposed Food Pantry Salisbury, MA

Bayside Engineering has prepared this traffic memorandum to qualitatively assess the traffic impacts associated with the re-use of the existing building at 114 Bridge Road in Salisbury, MA.

As currently proposed, the Project will consist of the renovation of the existing 23,438 square foot (sf) building into a Food Hub (the 'Project'). Parking will be provided for 86 vehicles. Access will be provided by way of the existing two full movement driveways to Bridge Road.

This memorandum identifies existing conditions on Bridge Road, performed crash research for the length of Bridge Road in the site vicinity, compared trip generation projections, and offers an opinion on the expected Project's impacts. Based on the analysis, compared to the existing office building, the proposed project would have less of an impact during the weekday morning peak hour and a comparable impact during the weekday evening peak hour compared to the former office use.

#### **EXISTING CONDITIONS**

Bridge Road (Route 1) is under the jurisdiction of the Massachusetts Department of Transportation (MassDOT) in the vicinity of the site. Bridge Road is functionally classified as a Rural Major Collector. Bridge Road provides one travel lane per direction that runs through Salisbury from the intersection with Beach Road southerly to the Merrimack River where the name changes to Newburyport Turnpike. Travel lanes are separated by a double yellow centerline, with marked shoulders provided. The posted speed limit in the vicinity of the site is 45 miles per hour (mph). Illumination is provided by luminaries mounted on poles. The pavement is in good condition having recently been resurfaced. There are no sidewalks along Bridge Road in the site vicinity. Land use along Bridge Road consists primarily of commercial uses.

Figure 1 shows the site in relation to Bridge Road.





Figure 1 Site Location Map

#### **COLLISION ANALYSIS**

#### Motor Vehicle Crash Data

Motor vehicle crash data for the study area was researched through MassDOT's IMPACT website. Crash data from 2017 through October 31, 2022 was reviewed. The motor vehicle crash data was reviewed to determine crash trends along Bridge Road in the site vicinity. No crashes were reported over the almost six-year period at the site driveways or on Bridge Road in the site vicinity.



#### **TRAFFIC GENERATION**

The site was previously used as a car dealership (building footprint was approximately 13,660 sf). Then, the building was converted and expanded by 9,778 sf to become an office building. The current proposal is to convert the existing 23.348 sf into a food pantry/delivery service company. There will also be a food market in the building with about 100 visitors per day.

#### Former Site Traffic Generation

Site generated traffic was based on trip-generation data published by the ITE *Trip Generation* manual<sup>1</sup> for the existing vacant office/contractor's building, assuming it were to be re-occupied. It was owned and occupied by ENPRO, an environmental clean-up/project company which had an office component, but also had many trucks on site that were going back and forth to their project sites.

Trip generation data for Land Use Code (LUC) 710 – General Office Building was reviewed. The existing building comprises approximately 23,348 sf of space. The trip generation for the existing building is summarized in Table 1. The trip generation worksheets are included in the Appendix.

	Former Use as an Office Building Trips <sup>a</sup>
Average Weekday Daily Traffic	328
Weekday Morning Peak Hour: Entering <u>Exiting</u> Total Weekday Evening Peak Hour: Entering <u>Exiting</u> Total	42 $-6$ $48$ $9$ $-41$ $50$

### TABLE 1 PREVIOUS TRIP GENERATION SUMMARY

<sup>a</sup>Based on ITE LUC 710 - General Office Building; 23.438 ksf.

<sup>&</sup>lt;sup>1</sup>*Trip Generation*, Eleventh Edition; Institute of Transportation Engineers; Washington, DC; 2021.



On a typical weekday, the existing office would have been expected to generate 328 daily vehicle trips (164 vehicles entering and 164 vehicles exiting). During the weekday morning peak hour, 48 vehicle trips (42 vehicles entering and 6 vehicles exiting) would have been expected. During the weekday evening peak hour, 50 vehicle trips (9 vehicles entering and 41 vehicles exiting) would be expected.

#### **Proposed Site Traffic Generation**

Site generated traffic for the proposed food pantry was based on characteristics of the proposed food pantry as there is no corresponding land use code in the current ITE *Trip Generation* manual<sup>2</sup>. The trip generation for the proposed food pantry was determined based on the expected number of employees, expected site operations and delivery activities. These characteristics are summarized in Table 2.

### TABLE 2PROPOSED FOOD HUB CHARACTERISTICS a

Food Hub Characteristics

Maximum of 50 employees, eight (8) to ten (10) per day in the food market.

Two to three tractor trailer trucks per week.

Five (5) to six (6) box trucks in/out, two (2) to three (3) times per week.

Three (3) small box trucks in/out daily, Monday to Friday.

Food Market within building with 100 visitors per day. Food Market expected to be open up to six (6) hours per day, up to four (4) days per week, including Saturday. Hours expected to vary between 9:00 AM and 6:30 PM.

Office Hours for administrative staff are 8:00 AM to 4:00 PM. Up to fifteen (15) employees per day.

<sup>a</sup>Staffing estimates provided by Our Neighbors' Table.

Using the above information from Table 2 and increasing the daily numbers to account for miscellaneous trips (10% contingency), the Project's traffic generation was determined as summarized in Table 3. The trip generation worksheets are included in the Appendix.

<sup>2</sup>Ibid.



### TABLE 3 PROPOSED TRIP GENERATION SUMMARY

Average Weekday Daily Traffic	298
Weekday Morning Peak Hour: Entering Exiting Total Weekday Evening Peak Hour: Entering Exiting Total	$20 \\ 2 \\ 22 \\ 14 \\ 32 \\ 46$

<sup>a</sup>Based on expected food pantry characteristics.

On a typical weekday, the proposed Project is expected to generate 298 daily vehicle trips (149 vehicles entering and 149 vehicles exiting). During the weekday morning peak hour, 22 vehicle trips (20 vehicles entering and 2 vehicles exiting) are expected. During the weekday evening peak hour, 46 vehicle trips (14 vehicles entering and 32 vehicles exiting) are expected.

Table 4 compares the former office trip generation to those of the proposed Project.



### TABLE 4TRIP GENERATION COMPARISON

	Former Use as an Office Building Trips <sup>a</sup>	Proposed Food Hub Trips <sup>b</sup>
Average Weekday Daily Traffic	328	298
Weekday Morning Peak Hour:		
Entering	42	20
Exiting	<u>6</u>	2
Total	48	22
Weekday Evening Peak Hour:		
Entering	9	14
Exiting	<u>41</u>	32
Total	50	46

<sup>a</sup>From Table 1.

<sup>b</sup>From Table 3.

Compared to the existing office building, the proposed project would have less of an impact during the weekday morning peak hour and a comparable impact during the weekday evening peak hour compared to the former office use.



### APPENDIX

#### **TRIP GENERATION WORKSHEETS**

#### Former Office Space, Salisbury, MA

#### Land Use Code (LUC) 710 - General Office Building Source: Institute of Transportation Engineers (ITE) - 11th Edition

Average Vehicle Trips Ends vs:	1,000 Sq. Feet Gross Floor Area
Independent Variable (X):	23.438 ksf

#### AVERAGE WEEKDAY DAILY

Ln T = 0.87 Ln (X) + 3.05Ln T = 0.87 Ln (23.438) + 3.05Ln T = 5.79T = 328.42T = 328 vehicle trips with 50% (164 vph) entering and 50% (164 vph) exiting.  $R^2 = 0.78$ 59 Studies, Average Rate = 10.84 trips/ksf Avg size = 163 ksf (164 vph) exiting.

#### WEEKDAY MORNING PEAK HOUR OF ADJACENT STREET TRAFFIC

 $\begin{array}{ll} Ln \ T = \ 0.86 \ Ln \ (X) + 1.16 & R^2 = 0.78 \\ Ln \ T = \ 0.86 \ Ln \ ( \ 23.438 \ ) + 1.16 & 221 \ Studies, \ Average \ Rate = 1.52 \ trips/ksf \\ Ln \ T = \ 3.87 & Avg \ size = 201 \ ksf \\ T = \ 48.07 \\ T = \ 48 & vehicle \ trips \\ with \ 88\% \ ( \ 42 & vph) \ entering \ and \ 12\% \ ( \ 6 & vph) \ exiting. \end{array}$ 

#### WEEKDAY EVENING PEAK HOUR OF ADJACENT STREET TRAFFIC

Ln T = 0.83 Ln (X) + 1.29	$R^2 = 0.77$
Ln T = 0.83 Ln (23.438) + 1.29	232 Studies, Average Rate = 1.44 trips/ksf
Ln T = 3.91	Avg size = $199$ ksf
T = 49.81	
T = 50 vehicle trips	
with 17% ( 9 vph) entering and 83	% ( 41 vph) exiting.

#### SATURDAY DAILY

T =	2.21 * (X)	No Formula
T =	2.21 * ( 23.438 )	5 Studies, Average Rate = 2.21 trips/ksf
T =	51.80	Avg size = $94 \text{ ksf}$
T =	52 vehicle trips	
	with 50% ( 26 vpd) entering and	1 50% ( 26 vpd) exiting.
	1.11	1.11
SAT	URDAY MIDDAY PEAK HOUR OF	GENERATOR
T =	0.53 * (X)	No Formula
T =	0.53 * ( 23.438 )	3 Studies, Average Rate = 0.53 trips/ksf
T =	12.42	Avg size = $82 \text{ ksf}$
T =	12 vehicle trips	
	with 54% ( 6 vpd) entering and	1 46% ( 6 vpd) exiting.
	0.26	0.26


### Former Office Space, Salisbury, MA


#### Land Use Code (LUC) 710 - General Office Building Source: Institute of Transportation Engineers (ITE) - 11th Edition


Average Vehicle Trips Ends vs: Independent Variable (X): 1,000 Sq. Feet Gross Floor Area 23.438 ksf


Weekday Food P													
	Food Pantry Employees	2-3 TTT/wk	T/wk	5-6 Box Trucks	rucks	<b>3 Small Box trucks</b>	x trucks	Food Market Visitors	et Visitors	Administration	tration	Total	al
Time	Out	In2	Out2	In3	Out3	In4	Out4	In5	Out5	In6	Out6	In10	Out10
12:00-12:15 AM												0	0
12:15-12:30 AM												0	0
12:30-12:45 AM												0	0
12:45-1:00 AM												0	0
1:00-1:15 AM												0	0
1:15-1:30 AM												0	0
1:30-1:45 AM												0	0
1:45-2:00 AM												0	0
2:00-2:15 AM												0	0
2115-2130 AM												, c	
2-30-2-45 AM												, c	
MM 01-2-200-2												, c	
3.00-3.15 AM													
3:15_3:30 AM													
2:20 2:4E AM													
												- c	
3.43-4:00 AIVI													
4.10-4.13 AIVI													
4:13-4:30 AIM												5	
4:30-4:45 AM												0 0	0
4:45-5:00 AM												5	
5:00-5:15 AM													
NP 15-5:30 AM												-	-
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5:45-6:UU AIM													
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6:30-6:45 AM												-	-
0:45-7:00 AIM													
/:UU-/:15 AM													-
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Weekday	Food Pantry Employees	mployees	2-3 TTT/wk	'/wk	5-6 Box Trucks	<b>Frucks</b>	3 Small Box trucks	د trucks	Food Market Visitors	et Visitors	Admini	Administration	Total	al
Time	E	Out	In2	Out2	In3	Out3	In4	Out4	In5	Out5	In6	Out6	In10	Out10
11:45-12:00 PM	5					1			5	6			10	10
12:00-12:15 PM		5											0	5
12:15-12:30 PM					1				∞	S			6	5
12:30-12:45 PM													0	0
12:45-1:00 PM						1			8	8			8	6
1:00-1:15 PM													0	0
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1:30-1:45 PM													0	0
1:45-2:00 PM					1	1			8	8			6	6
2:00-2:15 PM													0	0
2:15-2:30 PM						1	1		8	8			6	6
2:30-2:45 PM					1		1						2	0
2:45-3:00 PM				1			1		6	8			10	6
3:00-3:15 PM		S				1							0	9
3:15-3:30 PM									∞	6			∞	6
3:30-3:45 PM													0	0
3:45-4:00 PM									9	8			9	8
4:00-4:15 PM												15	0	15
4:15-4:30 PM										9			0	9
4:30-4:45 PM													0	0
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11:15-11:30 PM													0	0
11:30-11:45 PM													0	0
11:45-12:00 AM													0	0
TOTAL	10	10	1	1	9	9	æ	œ	100	100	15	15	135	135



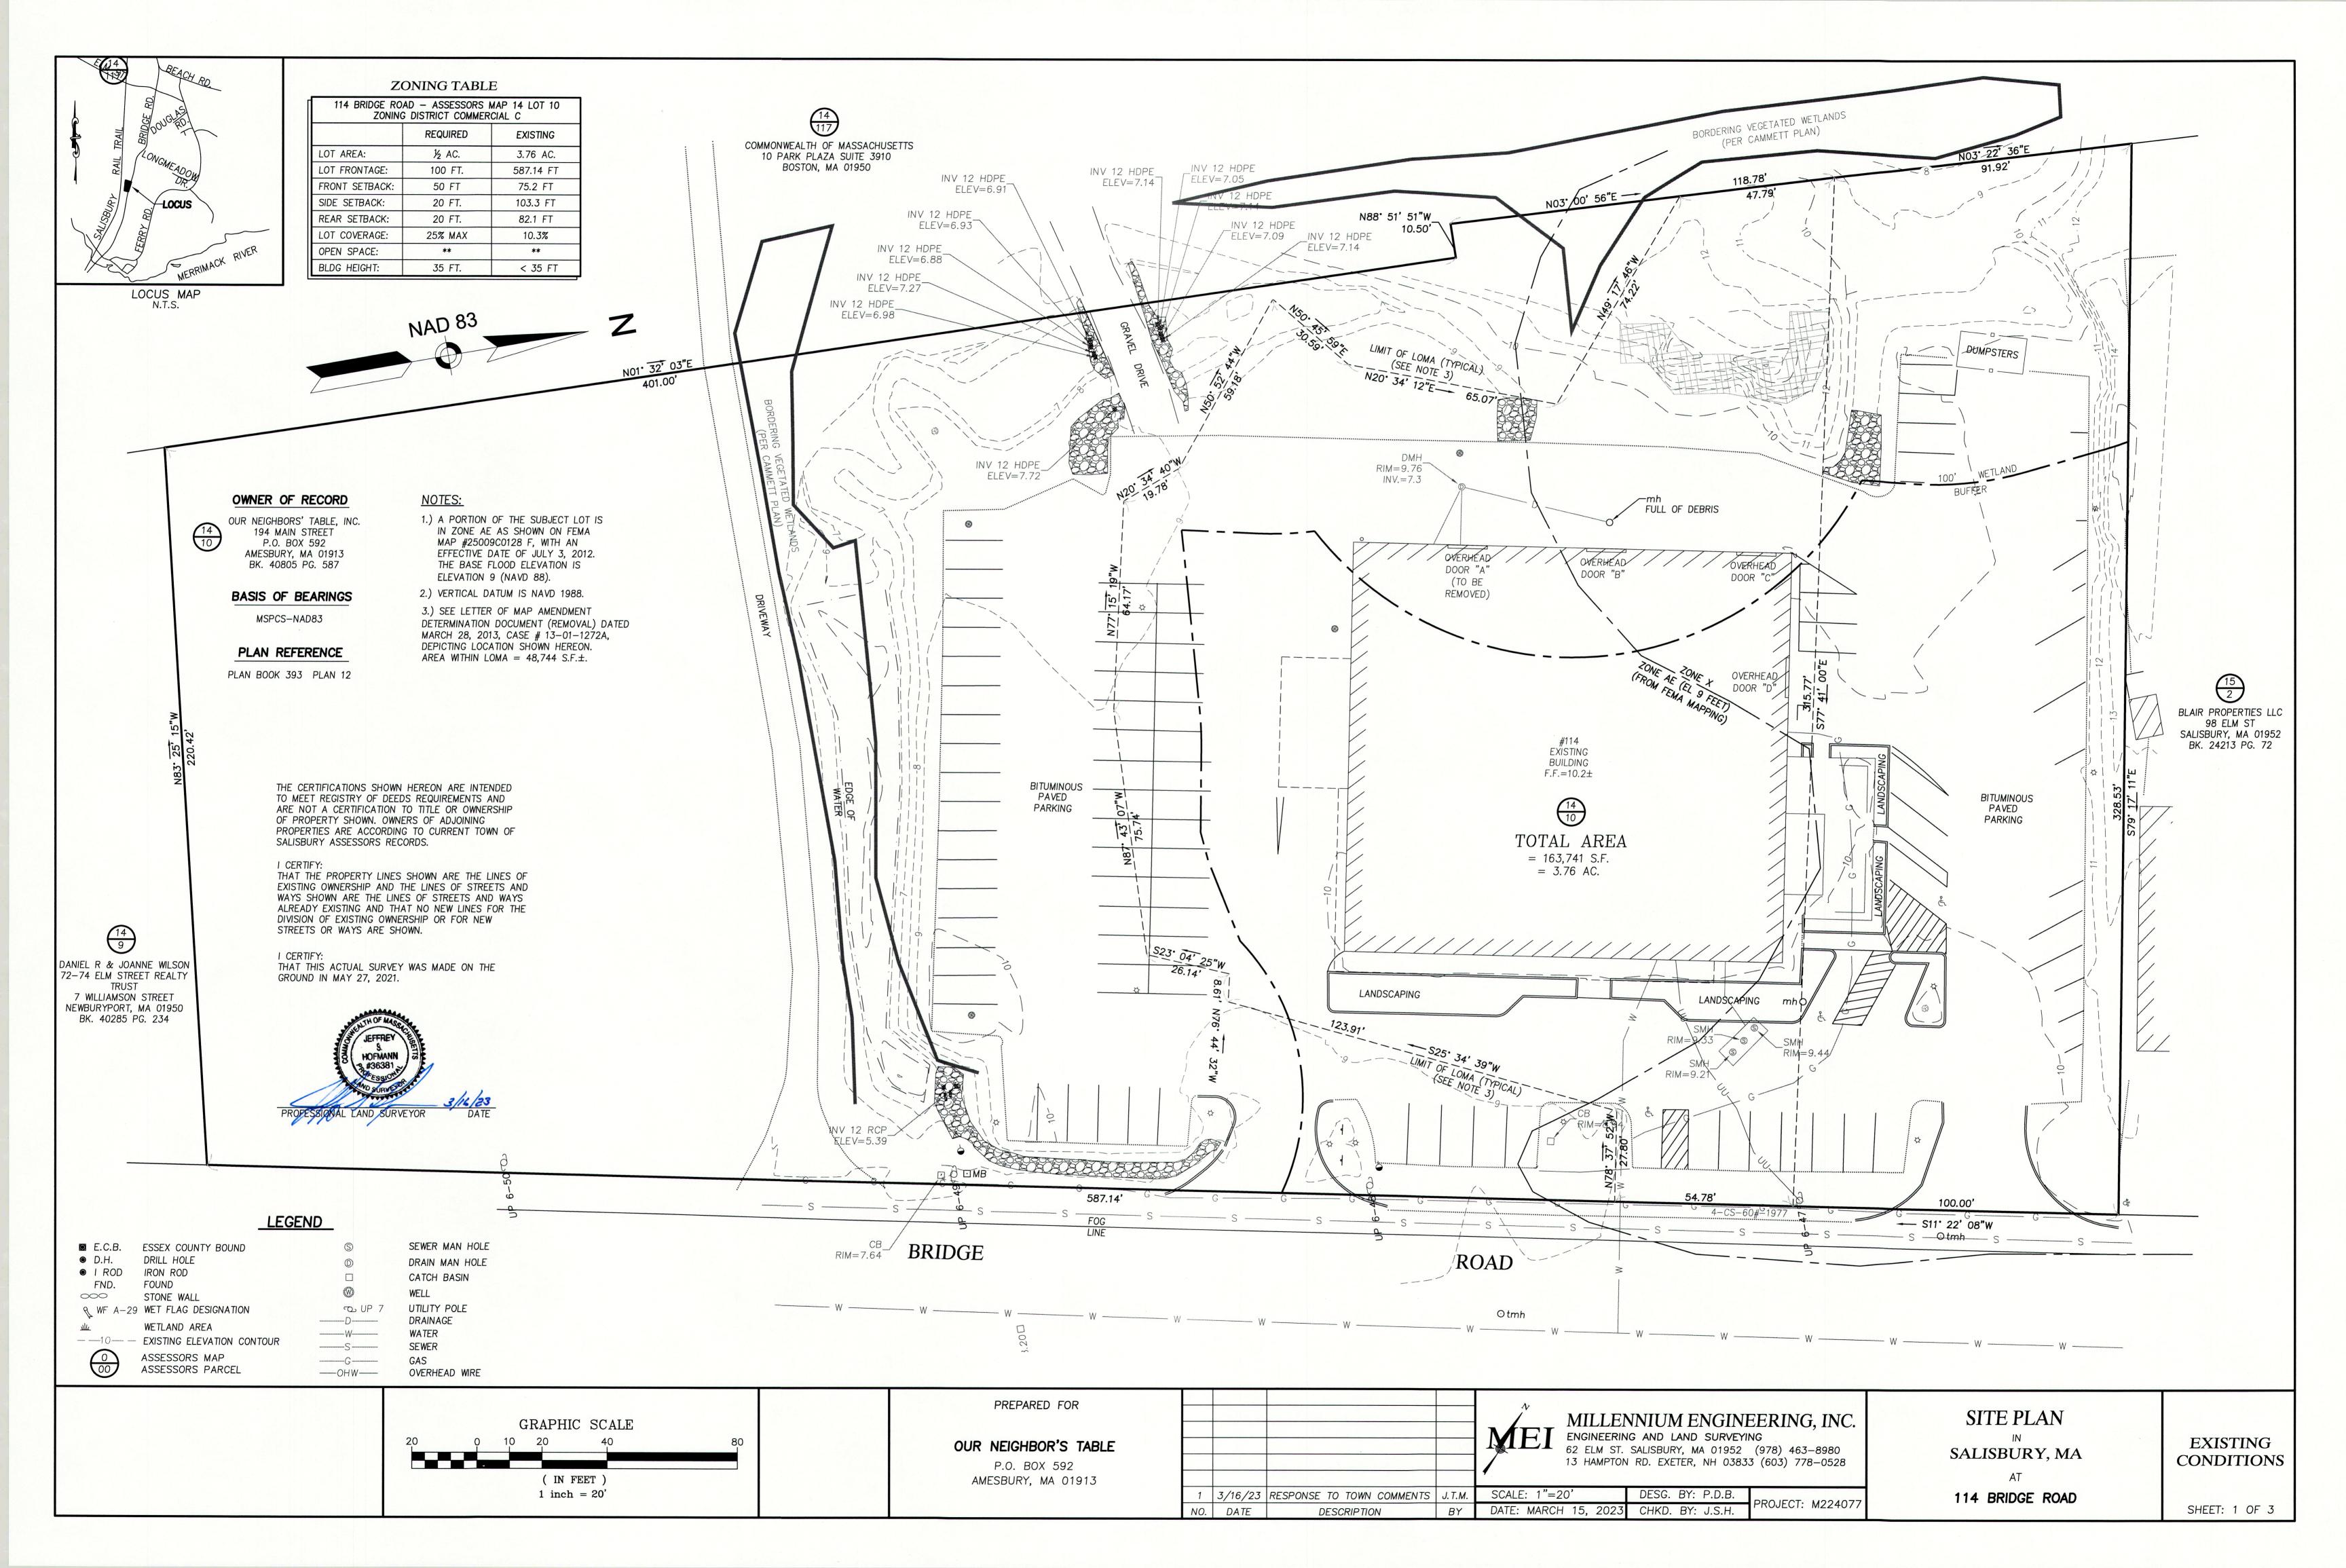

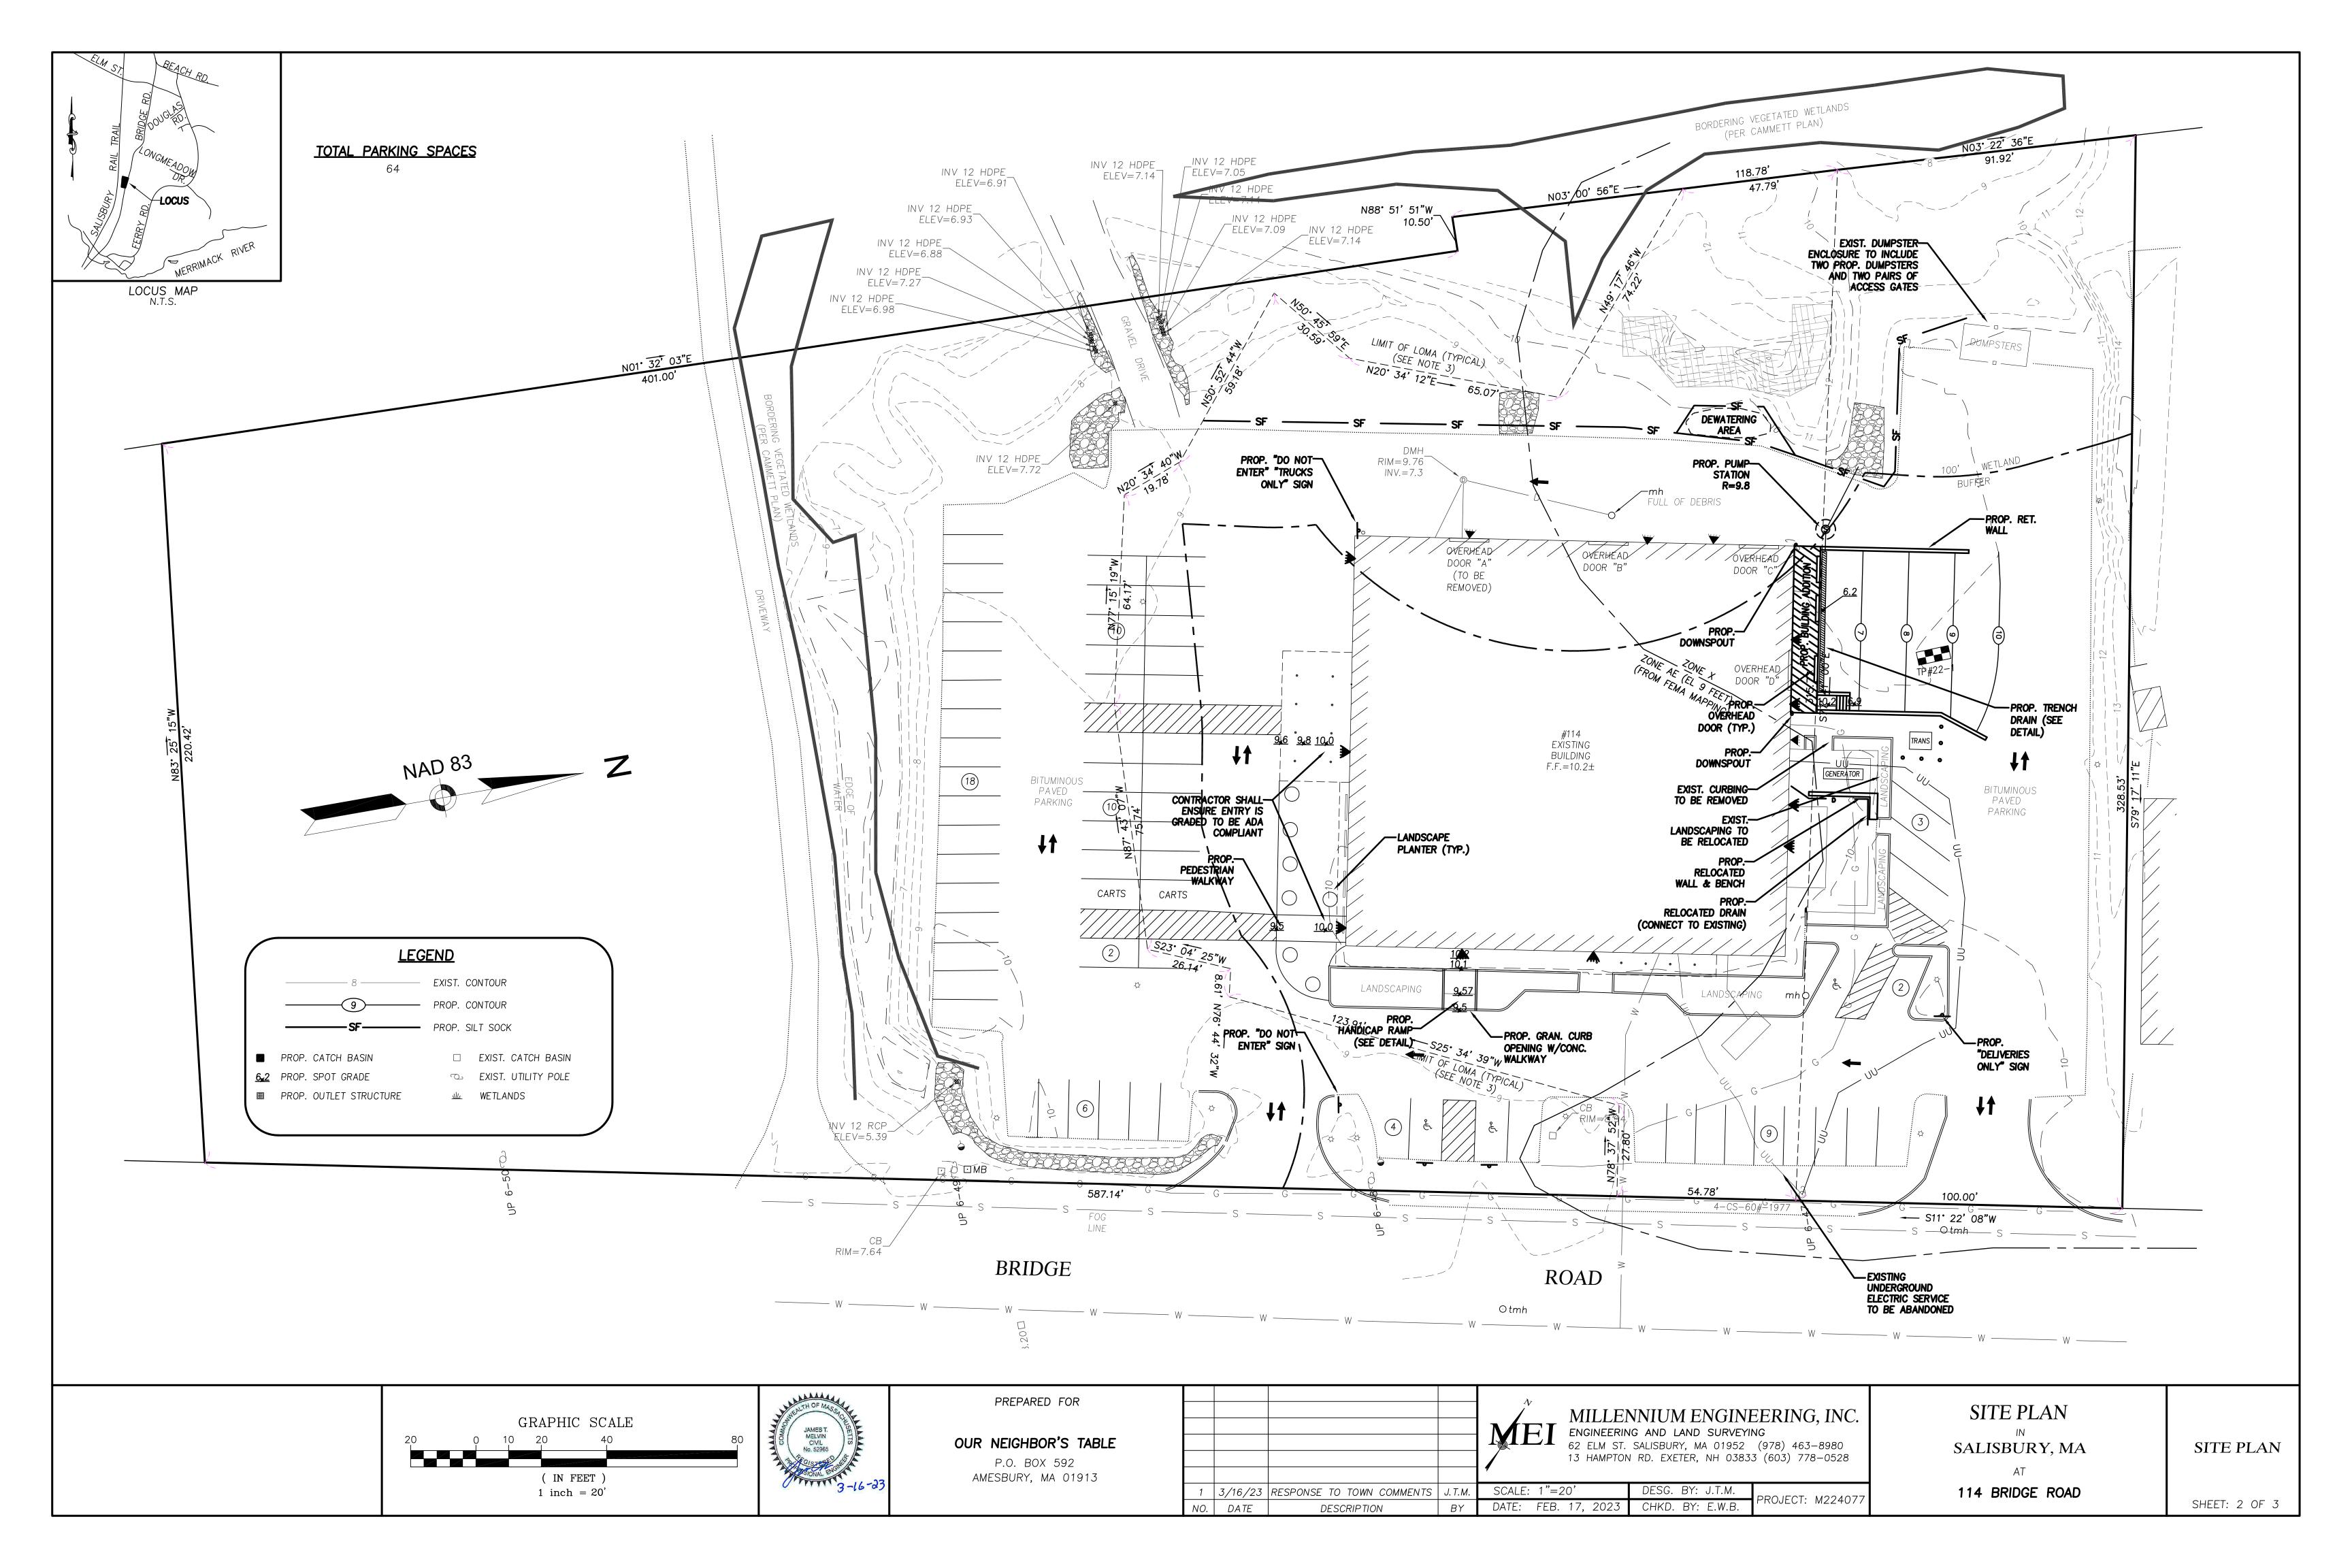

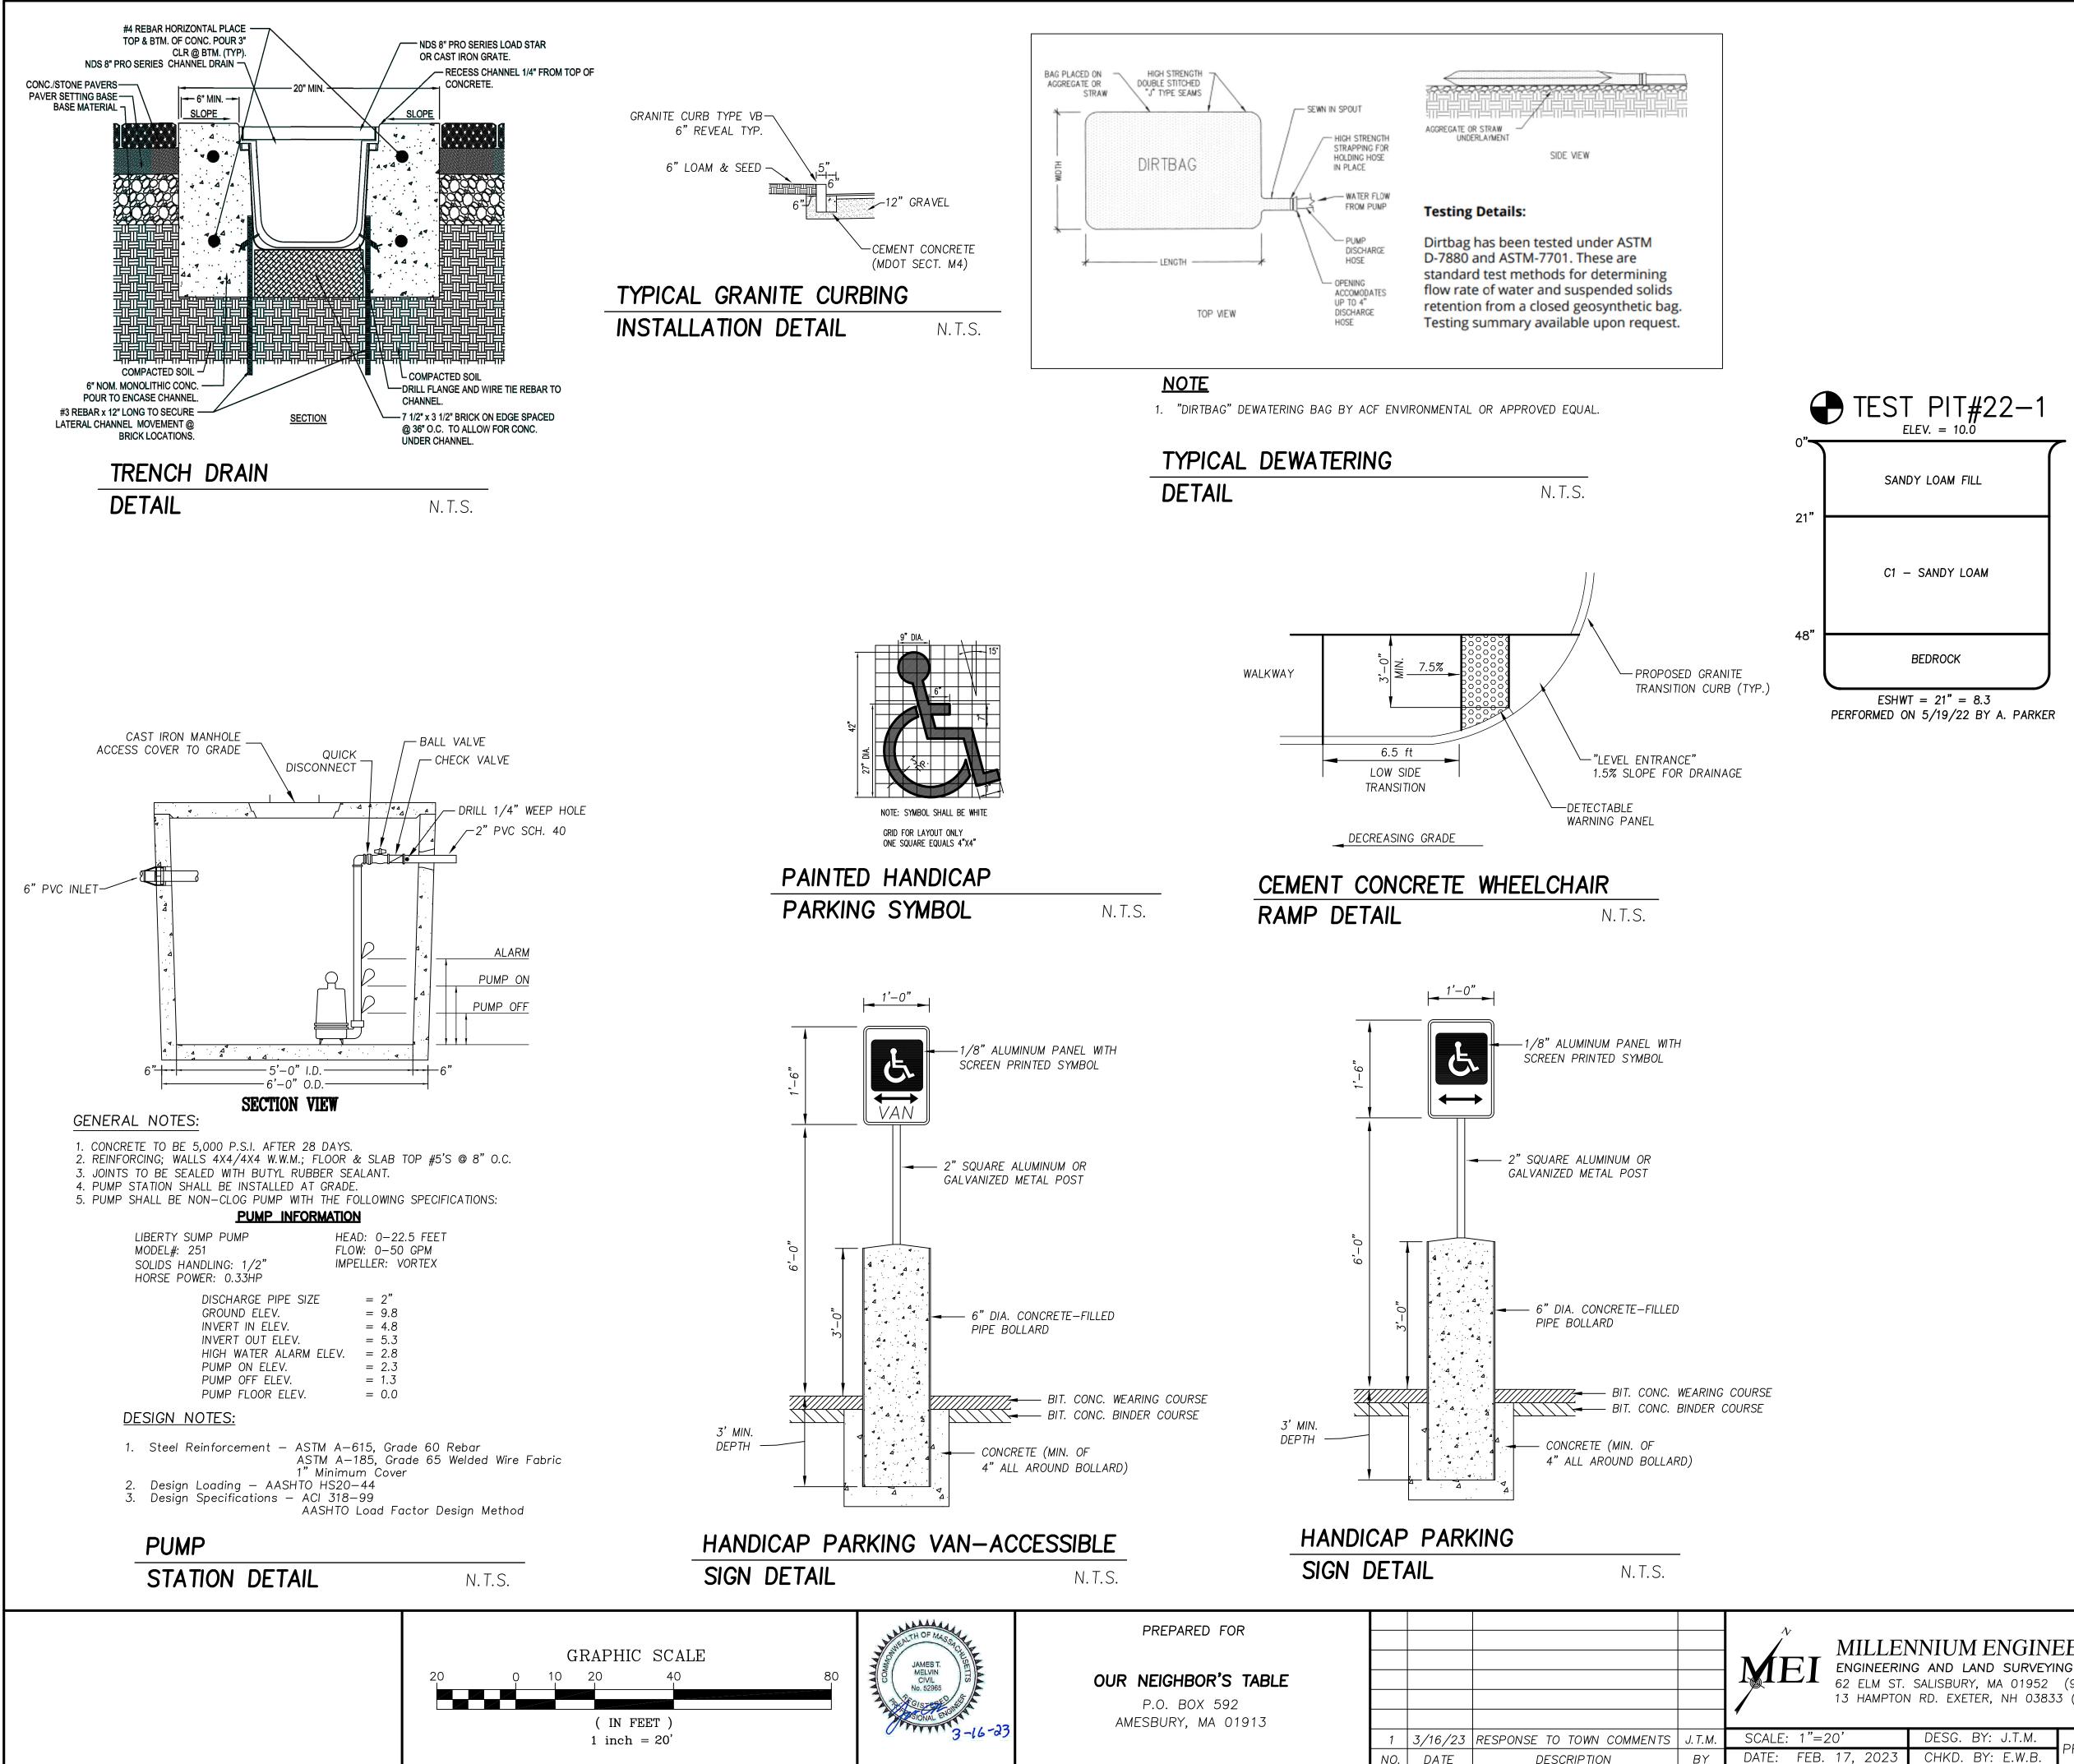

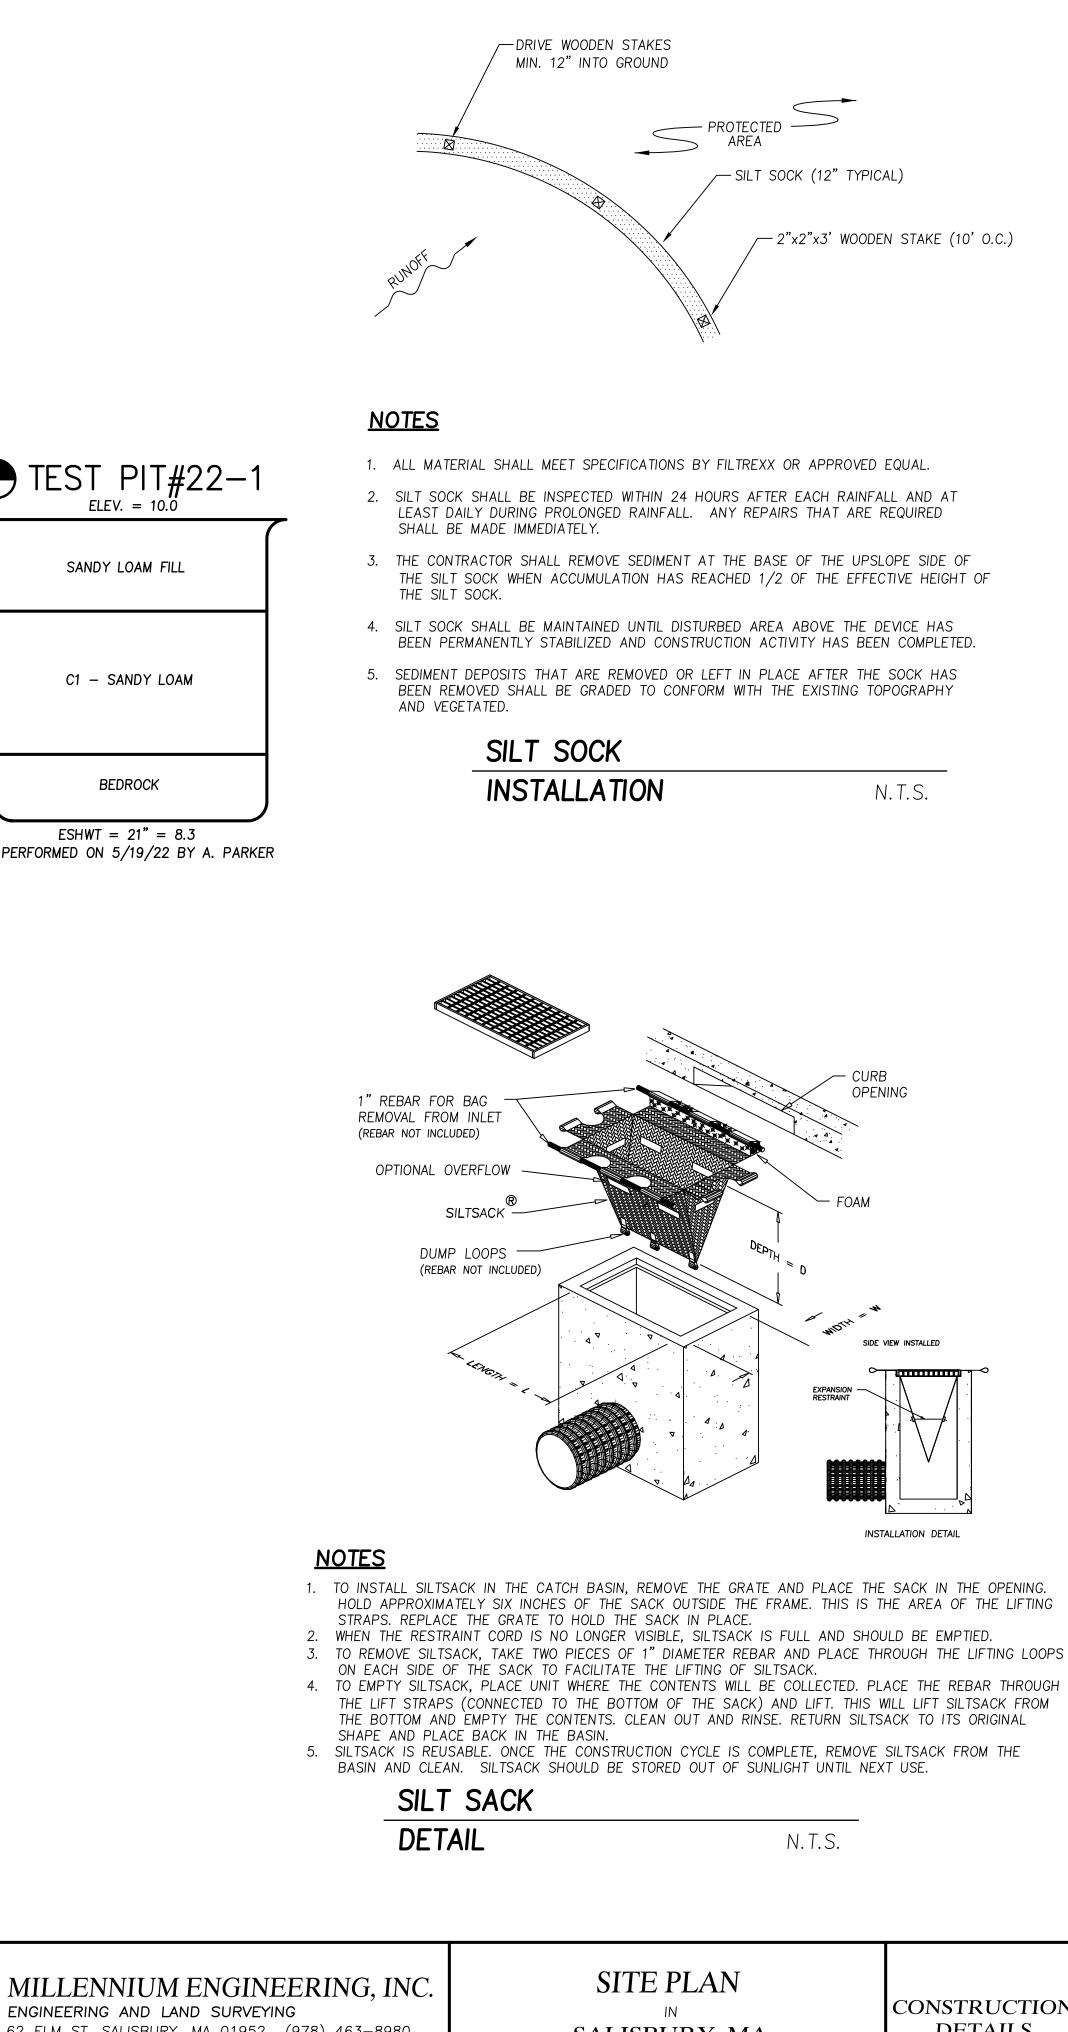62 ELM ST. SALISBURY, MA 01952 (978) 463-8980 13 HAMPTON RD. EXETER, NH 03833 (603) 778-0528

ROJECT: M224077

SALISBURY, MA AT 114 BRIDGE ROAD


DETAILS

SHEET: 3 OF 3

Schedul	e										
Symbol	Label	Image	QTY	Manufacturer	Catalog Number	Description	Lamp	Filename	Lumens per Lamp	LLF	Watta
$\bigcirc$	D		14	Lithonia Lighting	LDN4 30/10 LO4AR LD	4IN LDN, 3000K, 1000LM, CLEAR, MATTE DIFFUSE REFLECTOR, 80CRI; mounted at 11ft	LED	LDN4_30_10_L O4AR_LD.ies	922	0.9	10.58
	V		4	Lithonia Lighting	XXXXXXXX	Represents existing 8ft Vaportights; mounted at 11ft	LED	CSVT_L96_600 0LM_MVOLT_S WW3_80CRI.ie s	6268	0.9	48.51
	<b>W1</b>		9	Lithonia Lighting	WPX1 LED P1 30K Mvolt	WPX1 LED wallpack 1500lm 3000K color temperature 120-277 Volts; mounted at 8.5ft	LED	WPX1_LED_P1 _30K_Mvolt.ies	1537	0.9	11.49
	W2		6	Lithonia Lighting	WPX2 LED 30K Mvolt	WPX2 LED wallpack 6000lm 3000K color temperature 120-277 Volt; mounted at 17ft	LED	WPX2_LED_30 K_Mvolt.ies	5719	0.9	47.21

# Statistics

Description	Symbol	Avg	Max	Min	Max/Min	Avg
Ground	+	0.6 fc	16.2 fc	0.0 fc	N/A	N

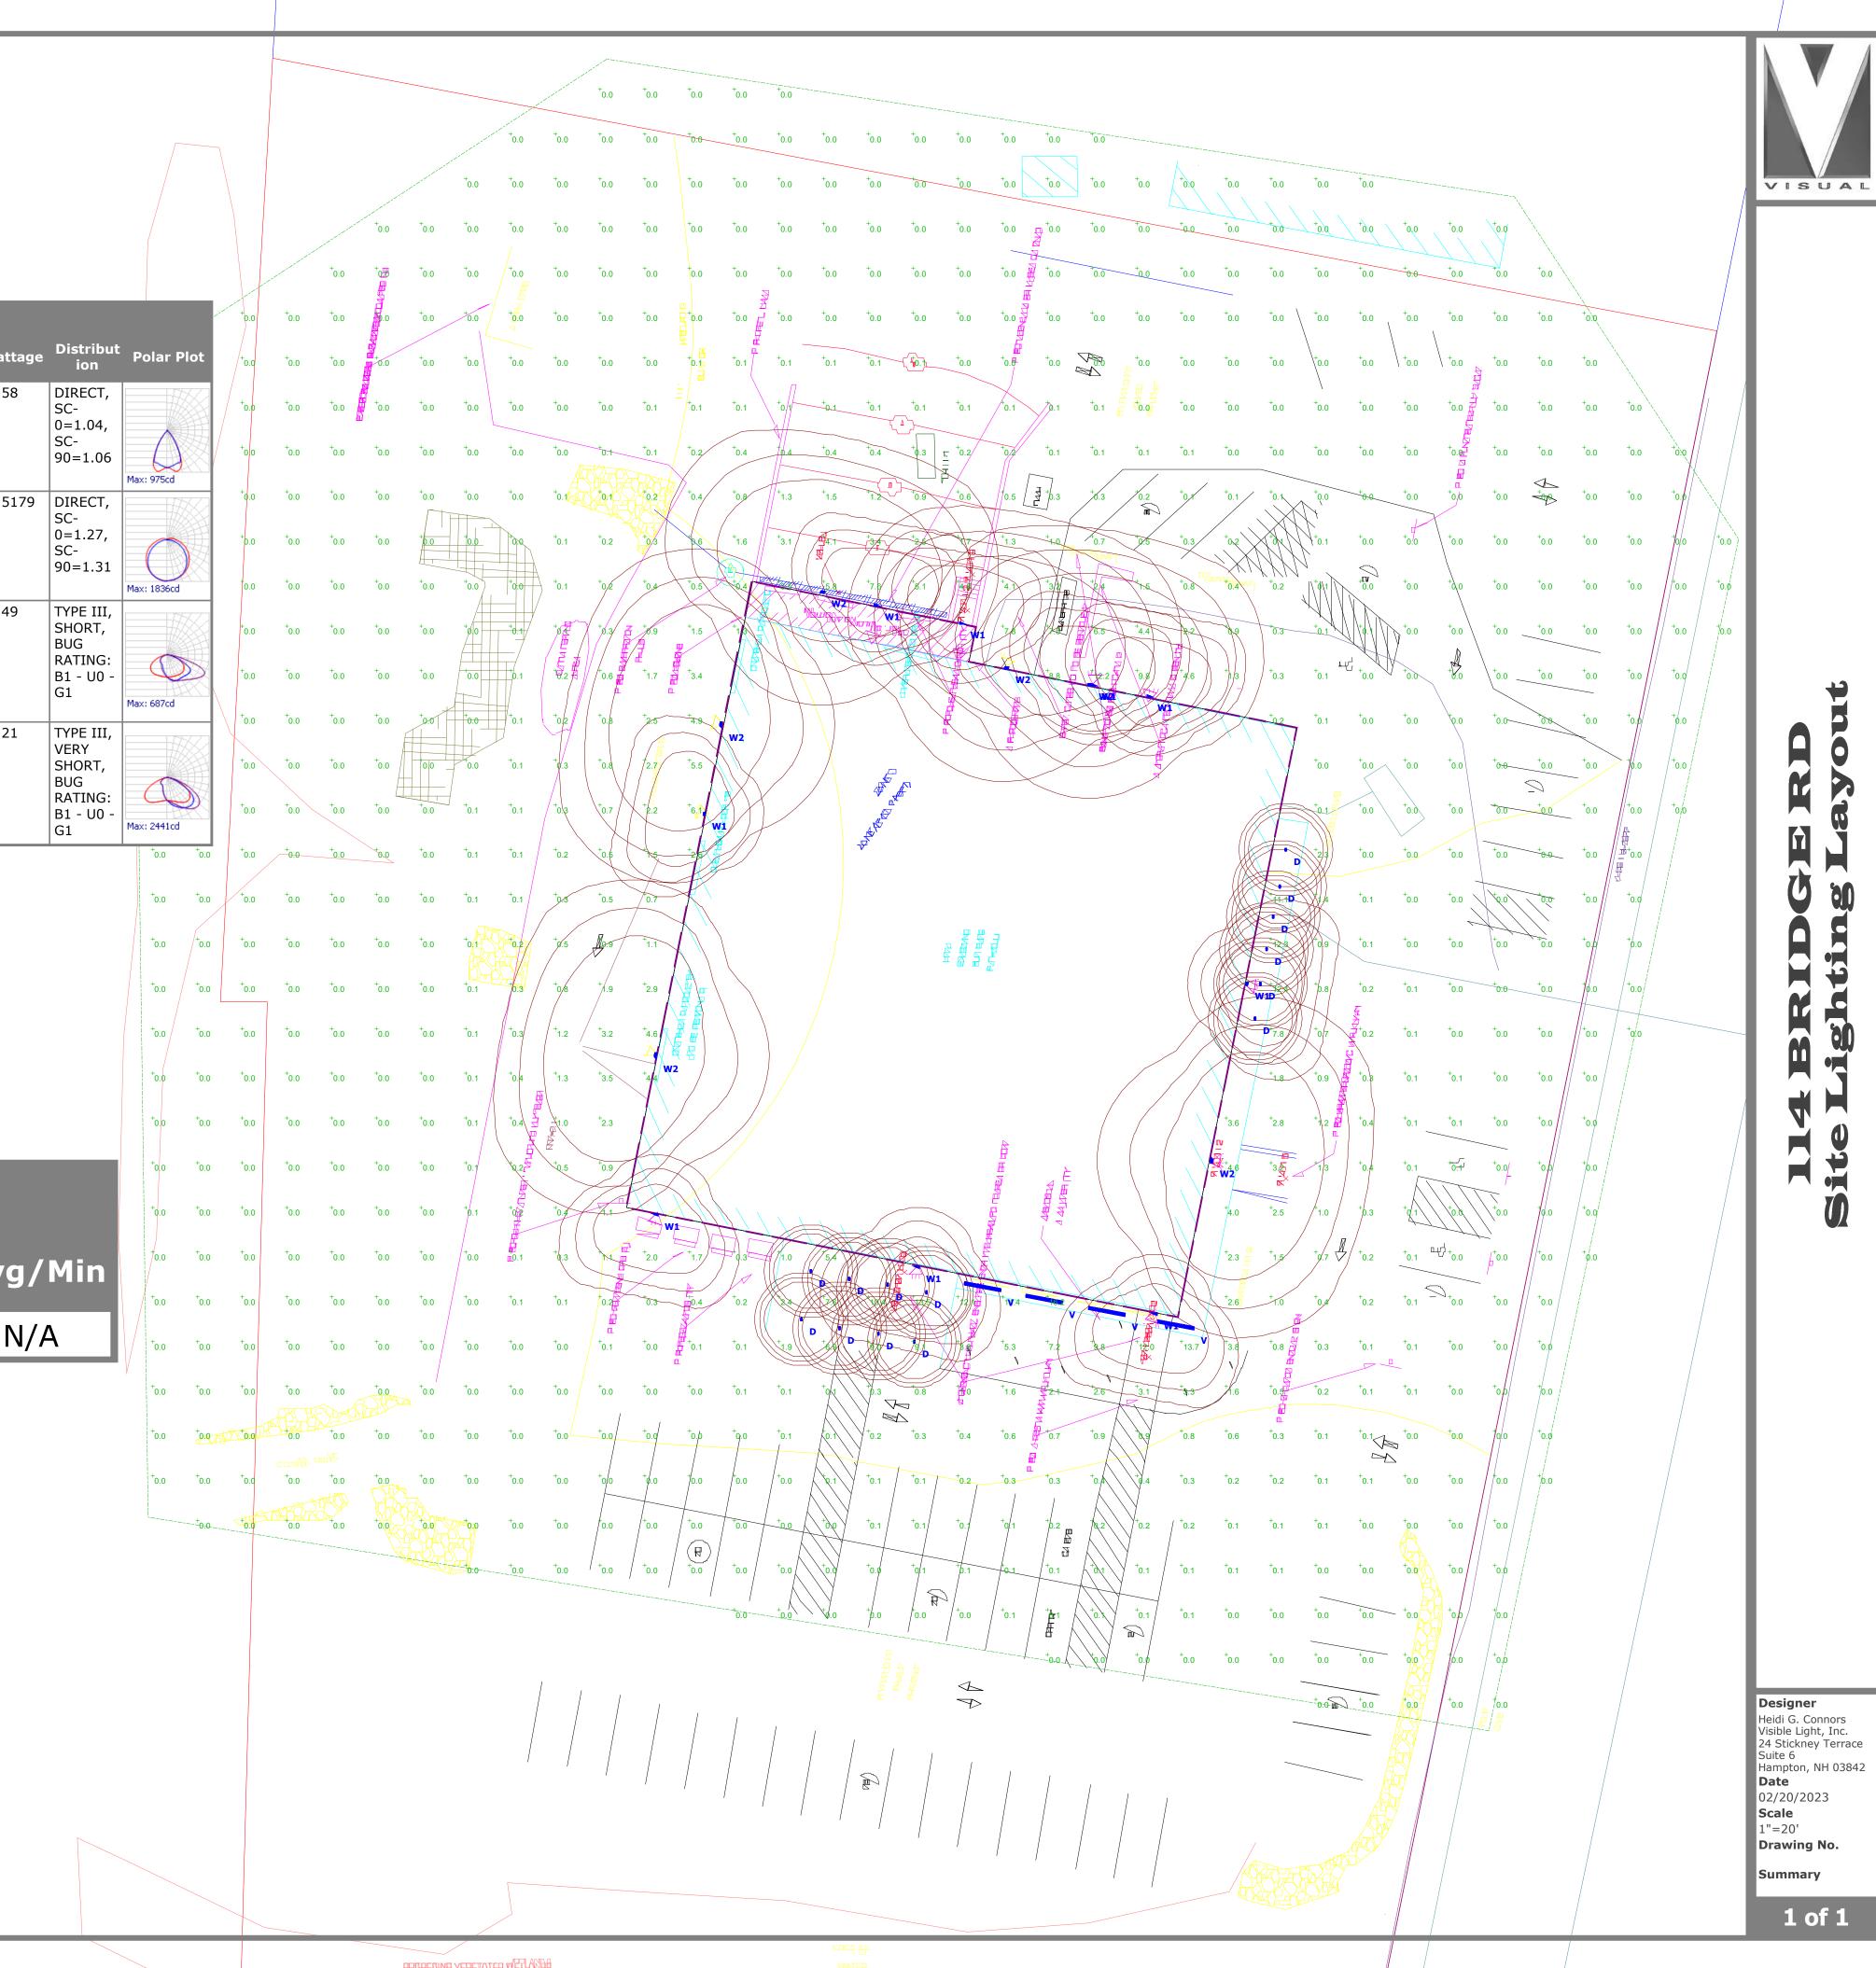

# Seacoast Food Hub Alterations to 114 Bridge Road Salisbury, Massachusetts 01952

## Architect

MERRIMACK DESIGN Architects 85 North Main Street, suite 222 White River Junction, Vermont 05001

contact: Gregory Colling, AIA telephone: 802-281-6478 e-mail: gcolling@merrimackdesign.com URL: www.merrimackdesign.com

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S1-4 Roof Key Plan

S2-1 Sections and Details

S2-2 Sections and Details

S2-3 Sections and Details

### **Project Manager**

Fishbone Project Management 34 Toppans Lane Newburyport, MA 01950 tel: (978) 335-0745

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> Mechanical H0-1 Legends, Notes & Abbreviations H1-1 First Floor Plan H1-2 Second Floor Plan H1-3 Roof Plan H2-1 Details H3-1 Details & Controls H4-1 Schedules H5-1 Specifications Electrical E0-1 Legends, Notes & Abbreviations E0-2 Site Plan E0-3 Site Details E1-1 Lighting Plan - First Floor E1-2 Lighting Plan - Second Floor E2-1 Power & Data Plan - First Floor E2-2 Power & Data Plan - Second Floor E3-1 Fire Alarm Plan - First Floor E3-2 Fire Alarm Plan - Second Floor E4-1 Panelboard Schedules E4-2 Equipment Schedules E5-1 One-Line Riser Diagrams E6-1 Specifications (1 of 2) E6-2 Specifications (2 of 2) Plumbing P0-1 Legends, Notes & Abbreviations PD1-0 Underslab Demolition Plan PD1-1 First Floor Demolition Plan PD1-2 Second Floor Demolition Plan P1-0 Underslab Plan P1-1 First Floor Plan P1-2 Second Floor Plan P2-1 Details P3-1 Specifications Fire Protection FP0-1 Legends, Notes & Abbreviations

FP1-1 First Floor Plan FP1-2 Second Floor Plan FP2-1 Details FP3-1 Specifications

### Structural Engineer

Tripi Engineering Services, LLC 433 Main Street, Suite 4 Hudson, MA 01749 tel: (781) 287-0077

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### MEP/FP Engineer

CSI Engineering,LLC 125 Aviation Avenue #4 Portsmouth, NH 03801 tel: (603) 319-8244

contact: James R. O'Brien, LEED AP email: JOBRIEN@csi-engineers.com

Graphic Symbols

### **Civil Engineer**

Millenium Engineering, Inc. 62 Elm Street Salisbury, MA 01952 tel: 978-463-8980

contact: Eric Botterman, P.E. email: EBotterman@Mei-MA.com

### Abbreviation Index

	-A-		-I-			
ACT	Acoustic Tile	ID	Inside Diameter			
ADJ	Adjustable	IN	Inches	4		
AFF	Above Finished Floor	INSUL	Insulation	A-2.2	▶	BUILDING ELEVATION
AL	Aluminum	INT	Interior	A-2.2		
	-B-		-J-			
BD	Board	JAN	Janitor			
BIT	Bituminous	JST	Joist			
B.O.	Bottom Of	JT	Joint	$\left( \begin{array}{c} 8 \\ \hline \end{array} \right)$		DETAIL
BLDG		JI		A7-7		BEINE
	Building		-L-	Ŭ		
BLKG	Blocking	LAV	Lavatory			
BOT	Bottom	LVL	Laminated Veneer Lumber			
-	-C-		-M-	A-3.2		BUILDING SECTION
CAB	Cabinet	MAX	Maximum			
CPT	Carpet (Wall to Wall)	MECH	Mechanical	•	_	
CJ	Construction Joint	MIN	Minimum			
CL	Center Line	MISC	Miscellaneous			WALL SECTION
CLG	Ceiling			A-3.2	<u> </u>	WALL SECTION
		MO	Masonry Opening			
CLO	Closet	MR GWB	Moisture Resistant Gypsum	•		
CLR	Clear		Wall Board			
CMU	Concrete Masonry Unit	MTL	Metal			ENLARGED PLAN
CT JT	Control Joint		-N-	A7-7/	-	ENLARGED PLAN
CO	Cased Opening	NIC	Not In Contract			
COL	Columns	NO	Number			
COMP	Composition	NOM	Nominal			
CONC	Concrete					WORK POINT
CONST	Construction	NTS	Not To Scale			
CONT	Continuous		-0-			
CONTR		OC	On Center			
	Contractor	OD	Outside Dimension			
CPT	Carpet	OFCI	Owner Furnished Contractor	P20		PLUMBING FIXTURE
СТ	Ceramic Tile	01 01	Installed	. 20		TAG
	-D-	OFI	Owner Furnished & Installed			
D BD	Drawing Board					
DBL	Double	OPP H	Opposite Hand		NUMBER	
DF	Drinking Fountain	OPNG	Opening			
DI	Drain Inlet	OPP	Opposite	4 (A7-1) 2		INTERIOR ELEVATION KEY
			-P-		SHEET	
DIA	Diameter	P&M	Patch & Match	3	NUMBER	
DIM	Dimension	PL, PLAS	Plaster			
DN	Down	PLMBG	Plumbing			
DRN	Drain	PLYWD	Plywood			
DWG	Drawing		Prefabricated	(206)		DOOR NUMBER
DISP	Dispenser	PREFAB				
DNSP	Downspout	PT	Pressure Treated			
	-E-	PTD	Painted			
			-R-	225		WINDOW NUMBER
EA	Each	REINF	Reinforcing			
EL	Elevation	REQ'D	Required			
ELEC	Electric	RM	Room			
ENTR	Entrance	RO	Rough Opening	5		PARTITION TYPE
EPXY	Ероху	NO		5		
EQ	Equal		-S-	×		
ETR	Existing To Remain	SCHED	Schedule			
EXTG	Existing	SHT	Sheet			
EXP	Expansion	SIM	Similar	( A )		COLUMN CENTER LINE
EXP JT	Expansion Joint	SPECS	Specifications			
EXT	Exterior	SS	Stainless Steel			
		STL	Steel		m	
	-F	STOR	Storage		\$	REVISION KEY
FD	Floor Drain	STRUCT	Structural	$\sum_{i=1}^{2} \sum_{j=1}^{2} \sum_{i=1}^{2} \sum_{j=1}^{2} \sum_{j=1}^{2} \sum_{j=1}^{2} \sum_{i=1}^{2} \sum_{j=1}^{2} \sum_{j$		REVISION REF
FDN	Foundation	SUSP	Suspended			
FE	Fire Extinguisher	303F	•			
FIN	Finish		-т-	— — — — — — — — — — — — — — — — — — —		ELEVATION
FL	Floor	TBD	To Be Determined	$\mathbf{\Psi}$		
FLASH	Flashing	Т.О.	Top Of			
FTG	Footing	TYP	Typical			
	-		-U-			
	-G-	UNO	Unless Noted Otherwise			4
GA	Gauge	UNO			Stateme	nt
GALV	Galvanized		-V-			
GB	Grab Bar	VCT	Vinyl Compression Tile			
GRND	Ground	VERT	Vertical			
GL	Glass	VEST	Vestibule			
GR	Grade	VIF	Verify In Field			
GWB	Gypsum Wall Board	VT	Vinyl Tile			HE BEST OF MY UNDERSTANDING THAT
		VW	View Window			RE DRAWN IN ACCORDANCE WITH ALL F
GWB PTD	Gypsum Wall Board Painted	VWC	Vinyl Wall Covering			OT LIMITED TO, THE AMERICANS WITH D
GYP	Gypsum	v v v C		TI		NDARDS FOR ACCESSIBLE DESIGN AND
	-H-		-W-		ACCES	SSIBILITY CODES, REGULATIONS, OR ST
HDWD	Hardwood	W/	With			
HGT	Height	W/O	Without			
HM	Hollow Metal	WC	Water Closet			
HORIZ	Horizontal	WD	Wood			
HR	Handrail	WP	Work Point			
HVAC						
	Heating, Ventilation & Air Conditioning					
				ARCHITE	CT'S SIGNATURE	LEDE
				/		
HW	Hot Water				CT 3 SIGNATURE	TIERE

### Construction Manager

Artisan Building Group 189 North Main Street, Suite 201 Middleton, MA 01949 tel: 978-767-8578

contact: Christopher Leitz email: cleitz@artisanbgi.com


### Building Data

Parcel ID:	14-10		
LOT AREA:	3.759 Acres (163,742 S	Sq. Ft.)	
LOT FRONTAGE:	587.14 Ft.		
ZONING DISTRICT:	C-Commercial		
BUILDING CODES:	MA STATE BUILDING 2015 INTERNATIONAL 2015 INTERNATIONAL 2015 INTERNATIONAL CODE	BUILDING CC	DE ILDING CODE
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### Locus Plan


ISSUED FOR PERMIT 2/13/2023

— 114 Bridge Road

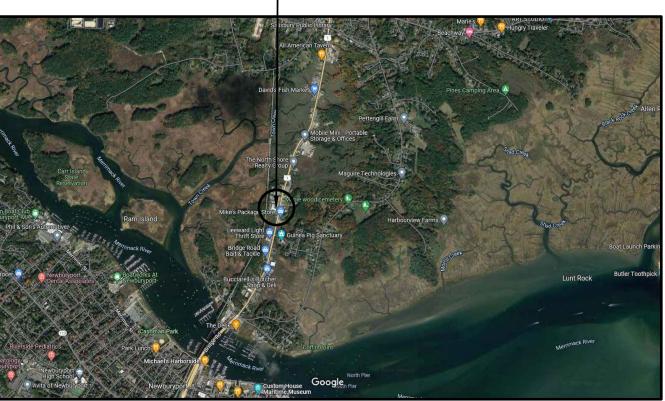


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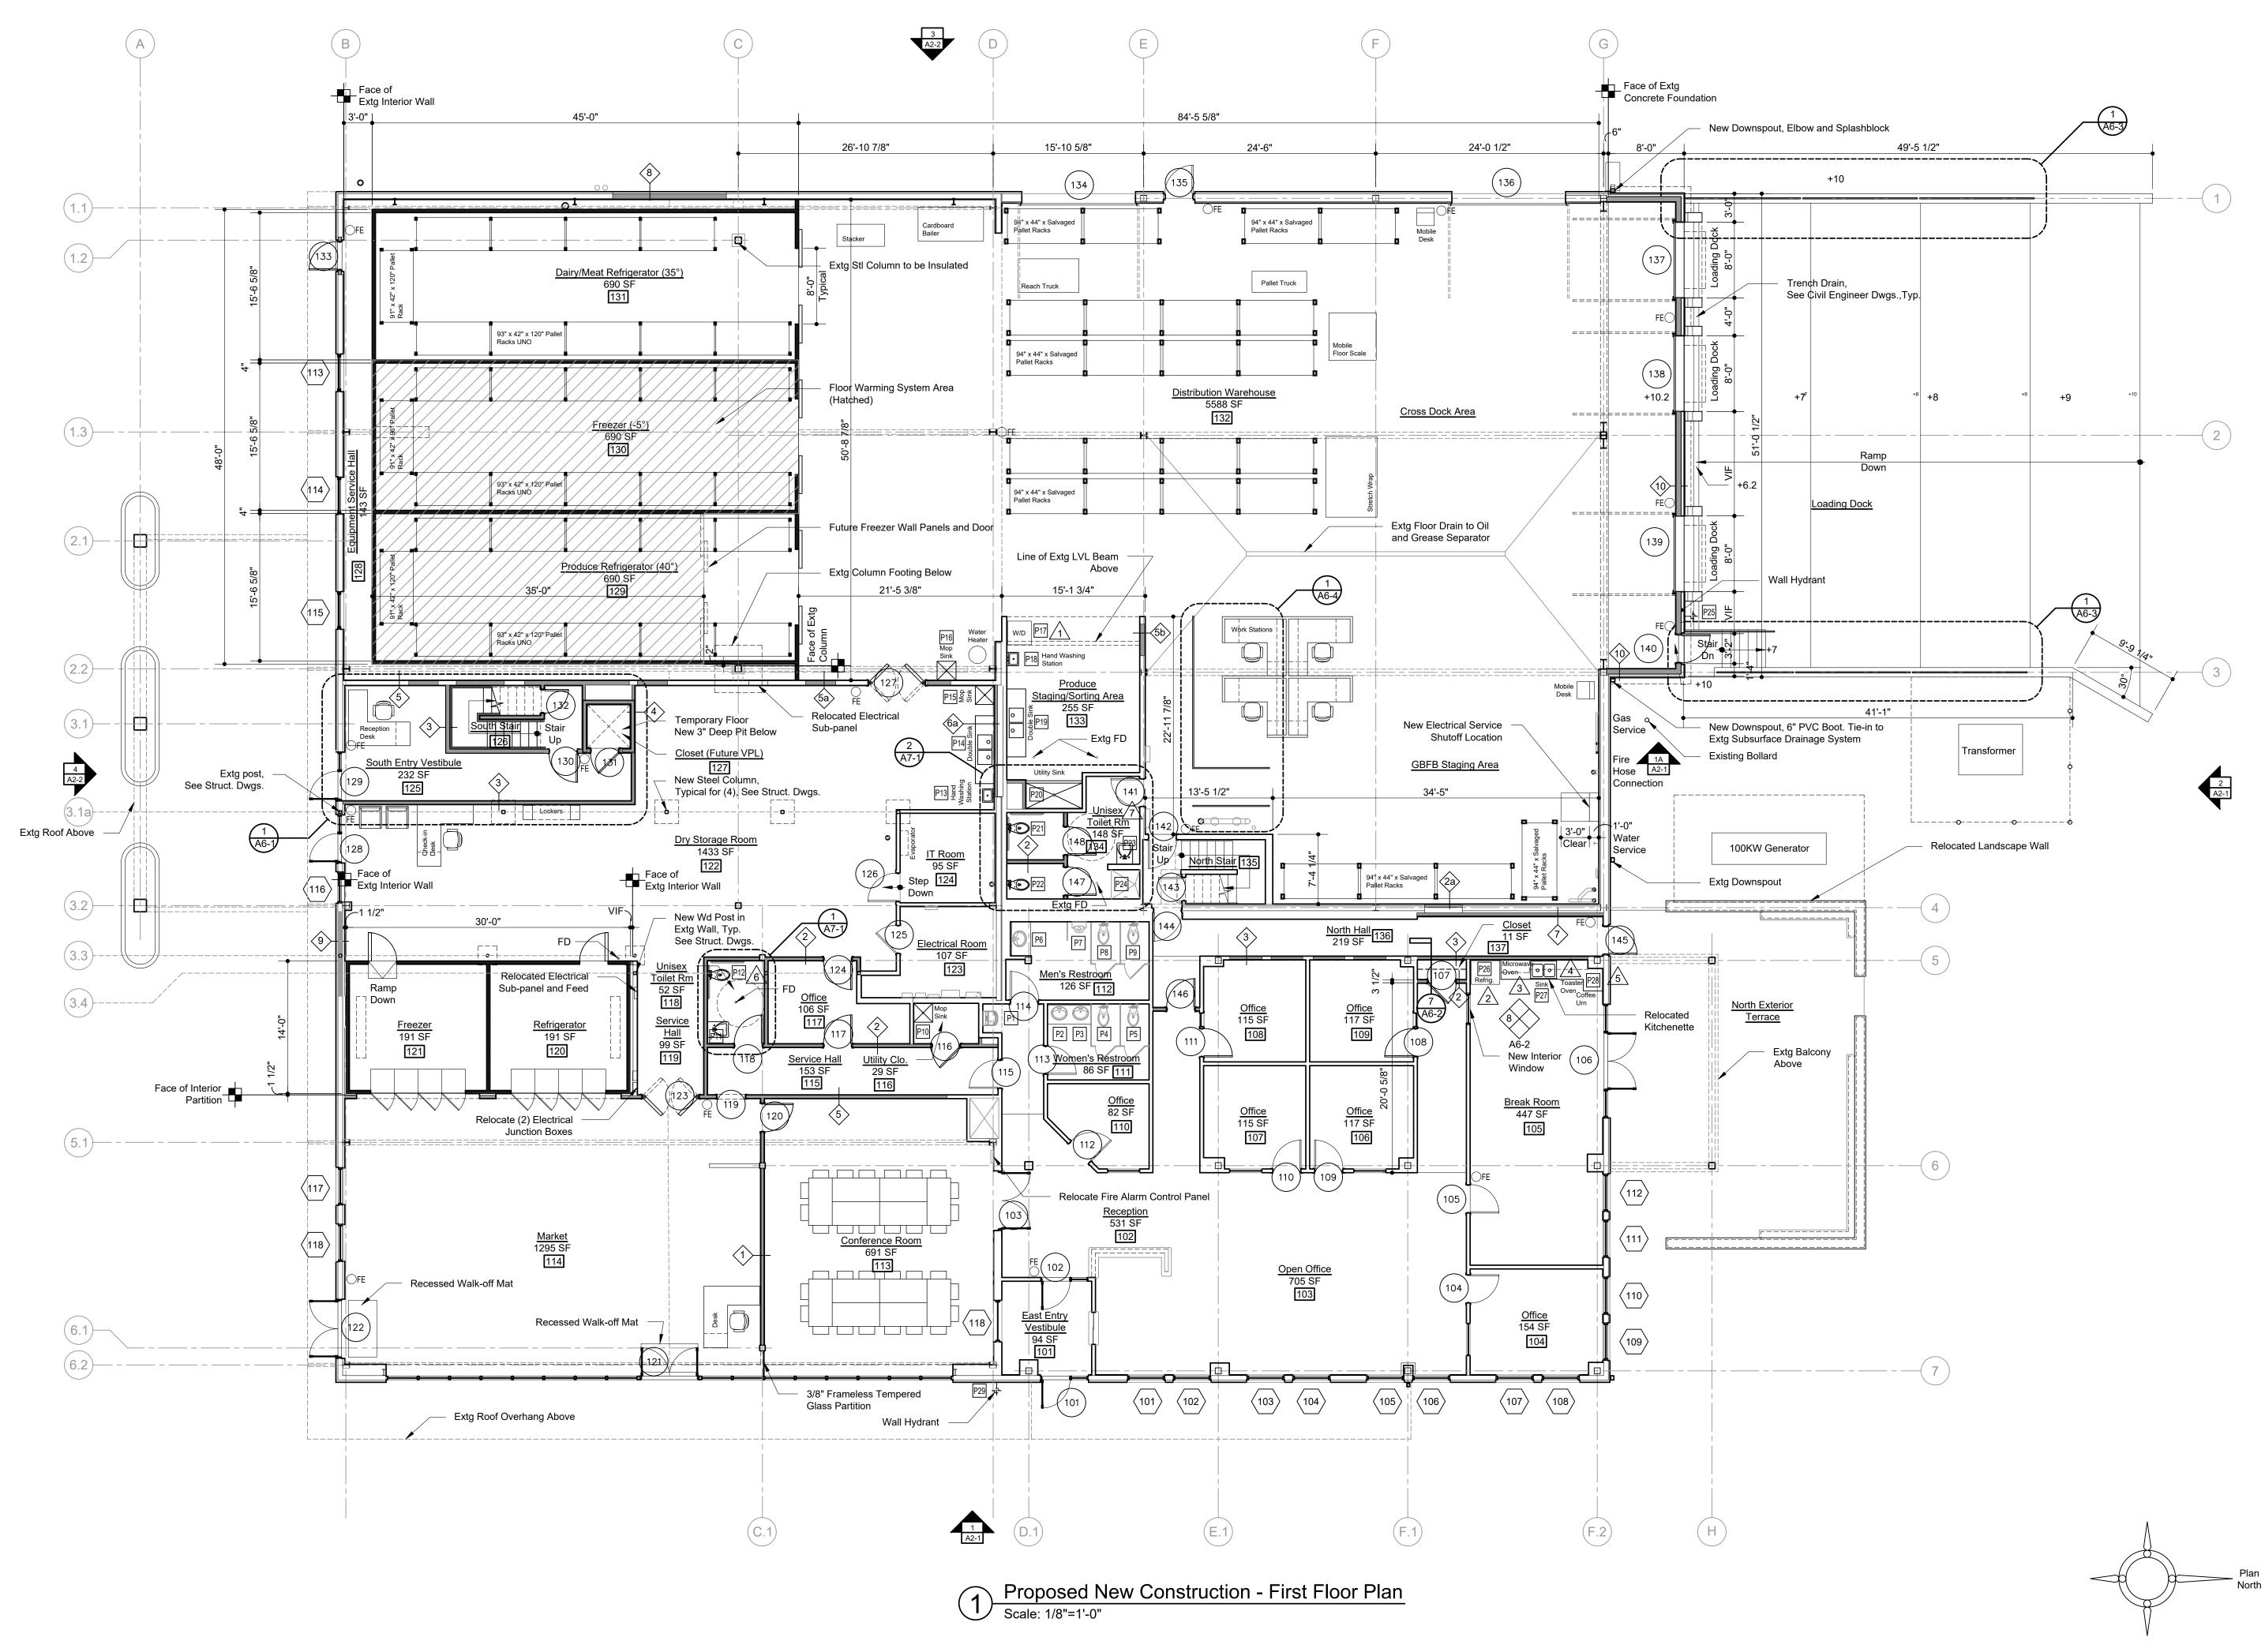
Date:

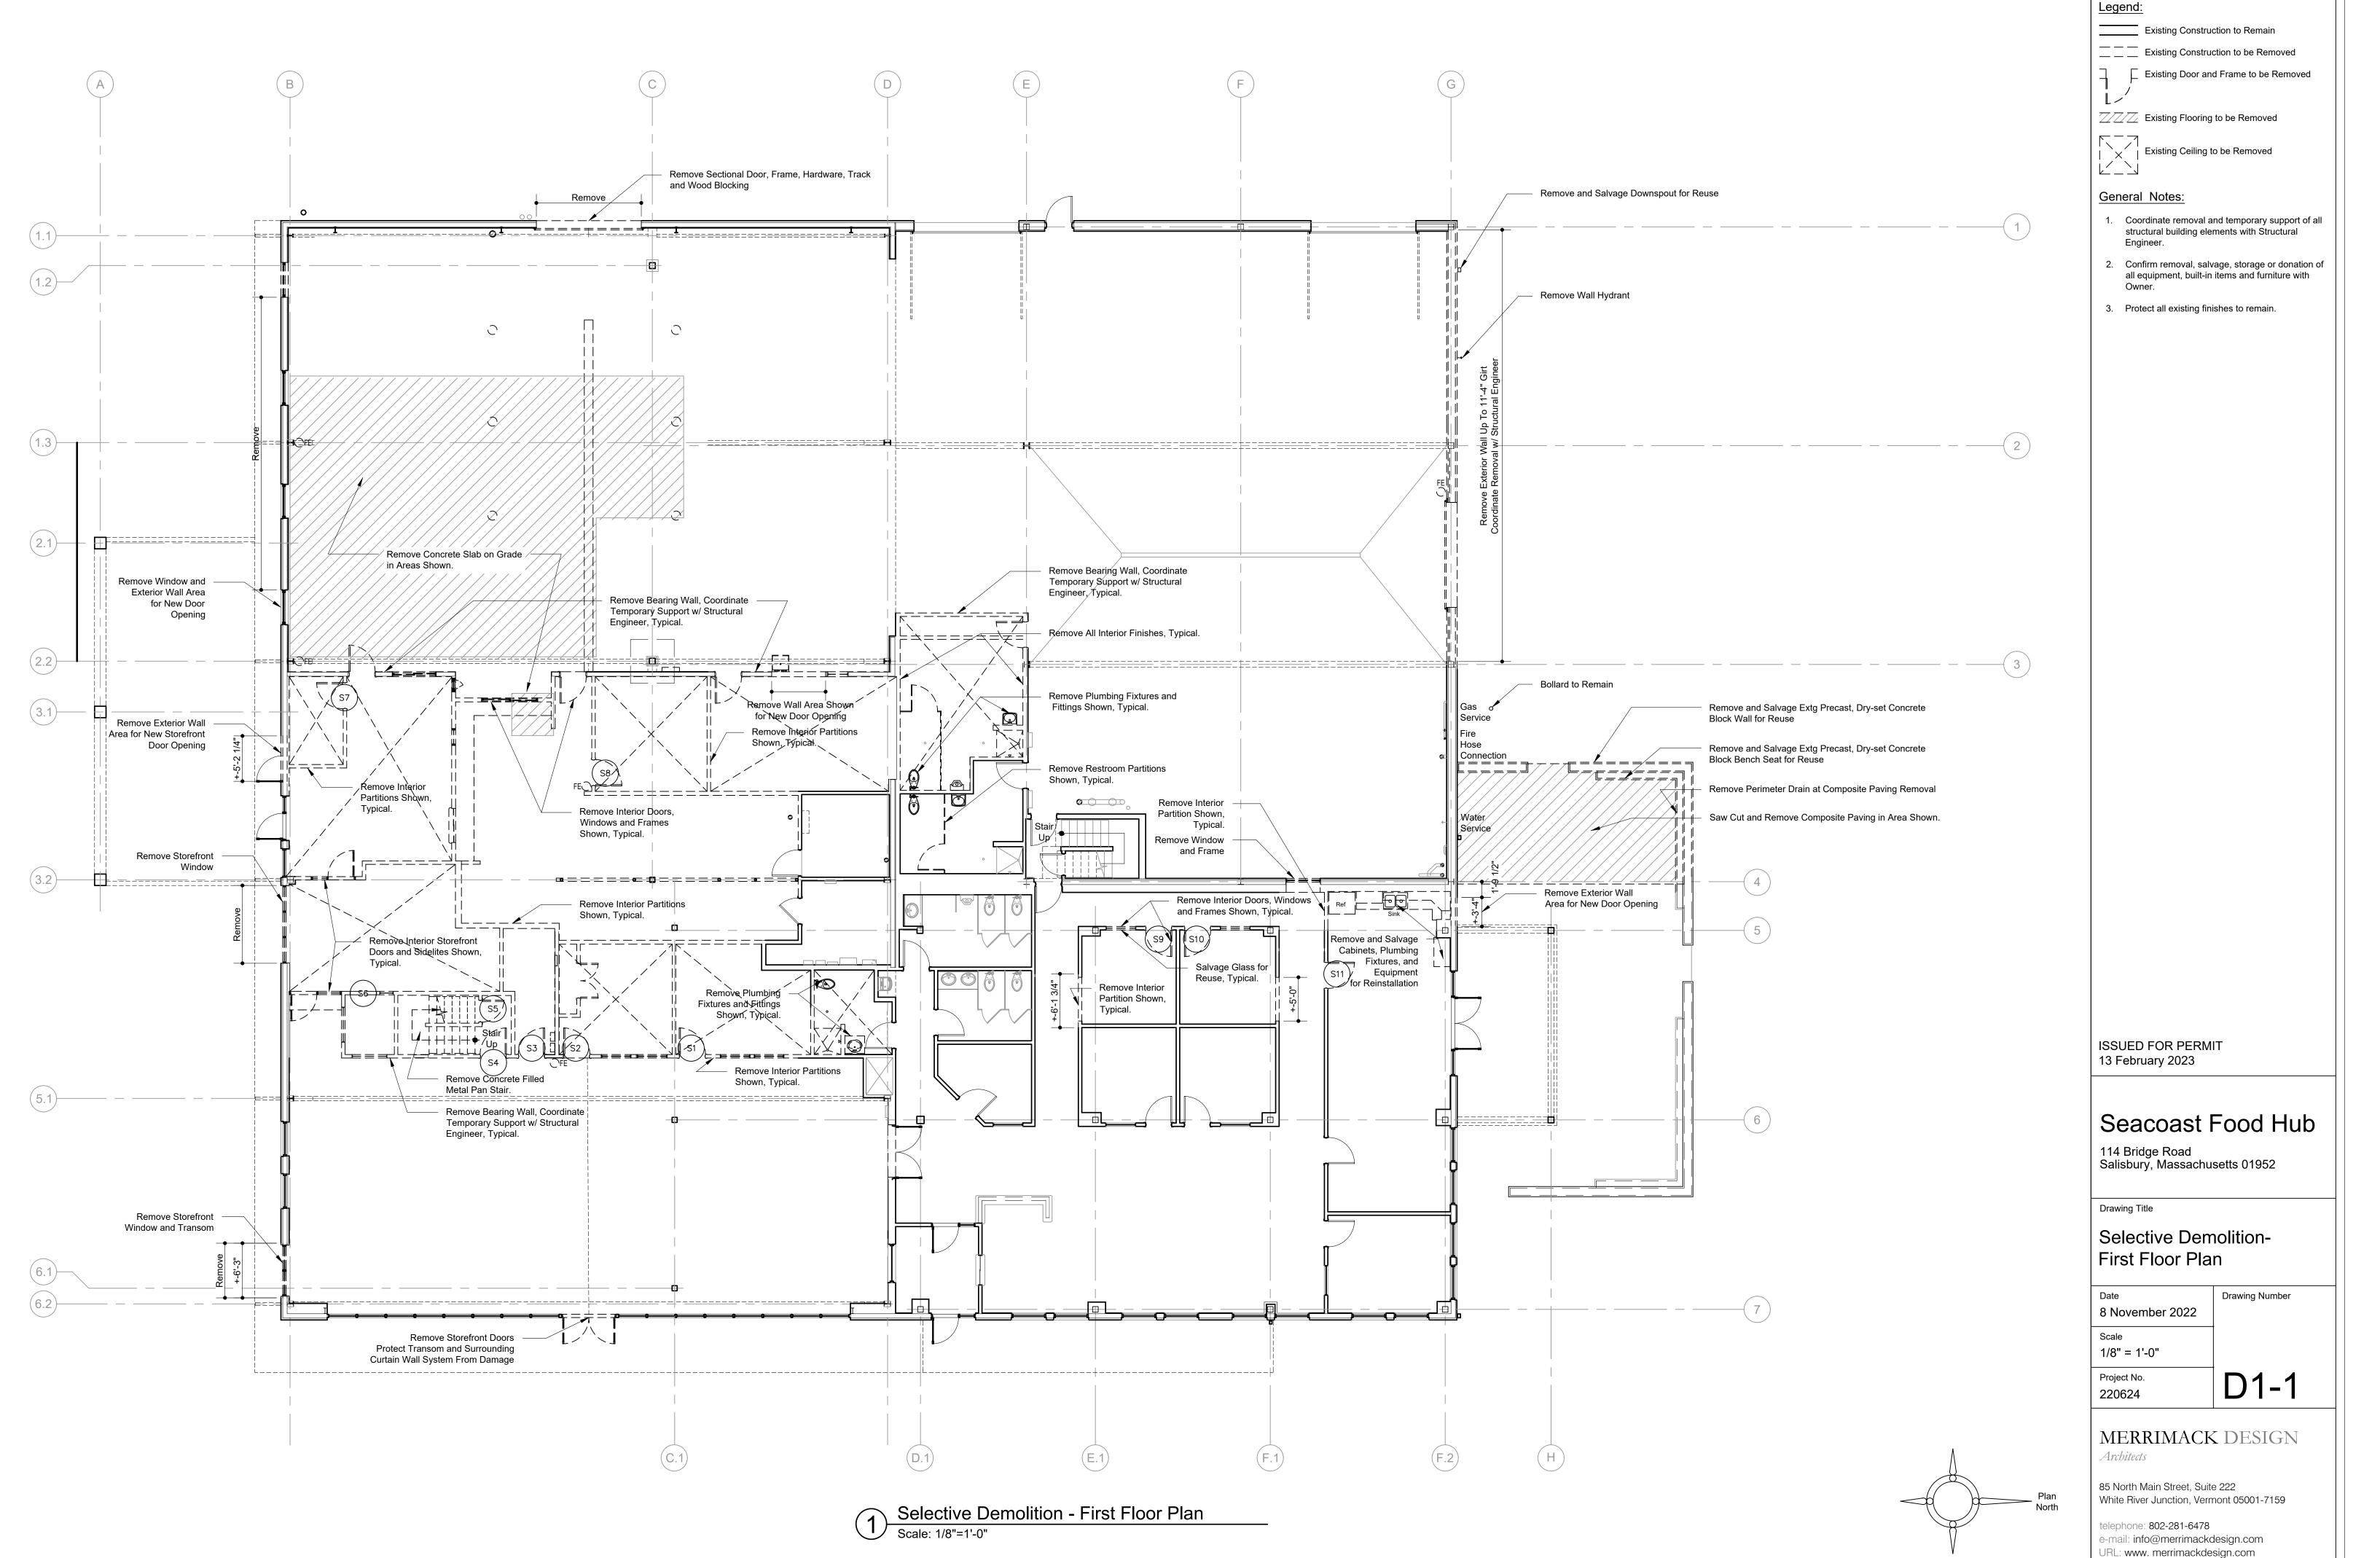

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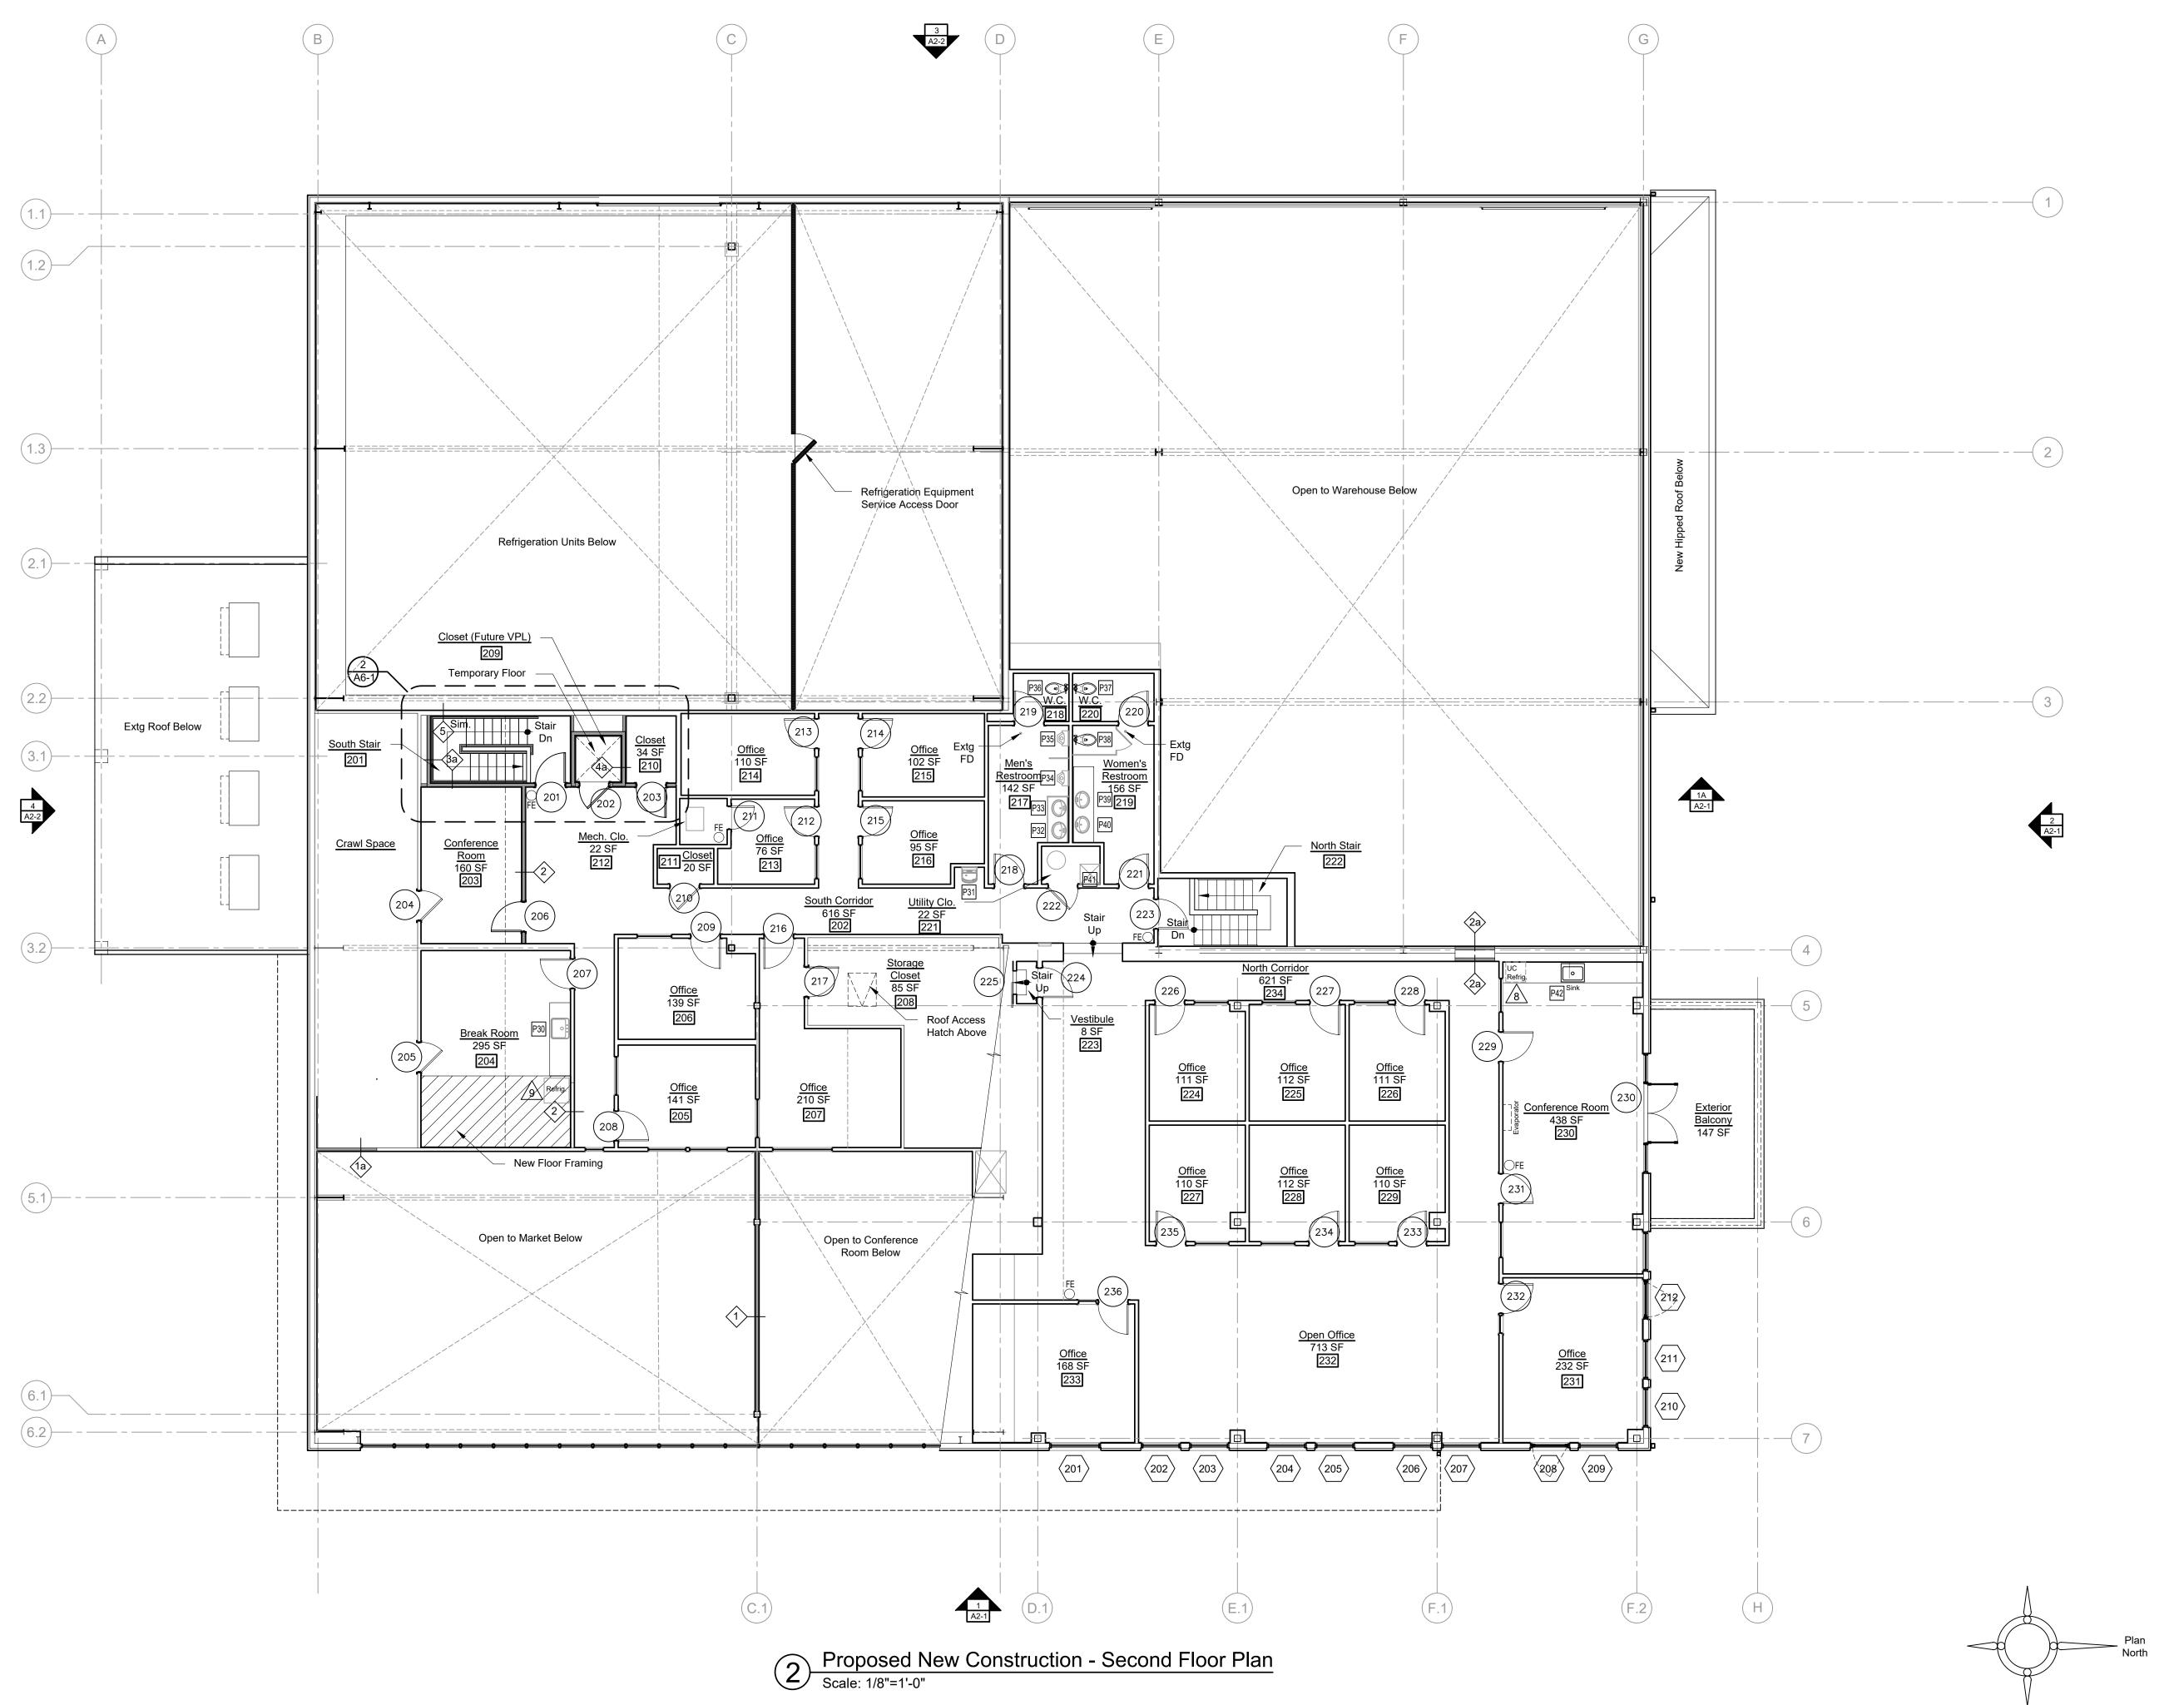


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Legend	
Existing Wall Cons	truction to Remain
	I Construction at New Work
	isting Wall Construction
New Wood/Metal F	rame Wall Construction
New Masonry Wal	Construction
New Reinforced C	oncrete Wall Construction
FE Wall Mounted Port	able Fire Extinguisher
New Reinforced C Radiant Heating S	oncrete Slab on Grade w/ ystem
General Notes	
	are to Rough Framing
Unless Noted Otherwi	se.
ISSUED FOR PERMI	т
13 February 2023	
•	
Seacoast F	Food Hub
114 Bridge Road	
Salisbury, Massachus	setts 01952
Salisbury, Massachus	setts 01952
Drawing Title	setts 01952
Drawing Title	
Drawing Title Proposed New	Construction
Drawing Title	Construction
Drawing Title Proposed New First Floor Plan	Construction
Drawing Title Proposed New First Floor Plan Date 6 May 2022	/ Construction
Drawing Title Proposed New First Floor Plan Date 6 May 2022 Scale	v Construction
Drawing Title Proposed New First Floor Plan Date 6 May 2022 Scale 1/8" = 1'-0"	r Construction
Drawing Title Proposed New First Floor Plan Date 6 May 2022 Scale 1/8" = 1'-0" Project No.	r Construction
Drawing Title Proposed New First Floor Plan Date 6 May 2022 Scale 1/8" = 1'-0"	v Construction
Drawing Title Proposed New First Floor Plan Date 6 May 2022 Scale 1/8" = 1'-0" Project No. 220624	r Construction Drawing Number
Drawing Title Proposed New First Floor Plan Date 6 May 2022 Scale 1/8" = 1'-0" Project No.	r Construction Drawing Number
Drawing Title Proposed New First Floor Plan Date 6 May 2022 Scale 1/8" = 1'-0" Project No. 220624 MERRIMACK Architects	r Construction Drawing Number A1-1 DESIGN
Drawing Title Proposed New First Floor Plan Date 6 May 2022 Scale 1/8" = 1'-0" Project No. 220624 MERRIMACK Architects 85 North Main Street, Suite	Construction Drawing Number
Drawing Title Proposed New First Floor Plan Date 6 May 2022 Scale 1/8" = 1'-0" Project No. 220624 MERRIMACK Architects	Construction Drawing Number
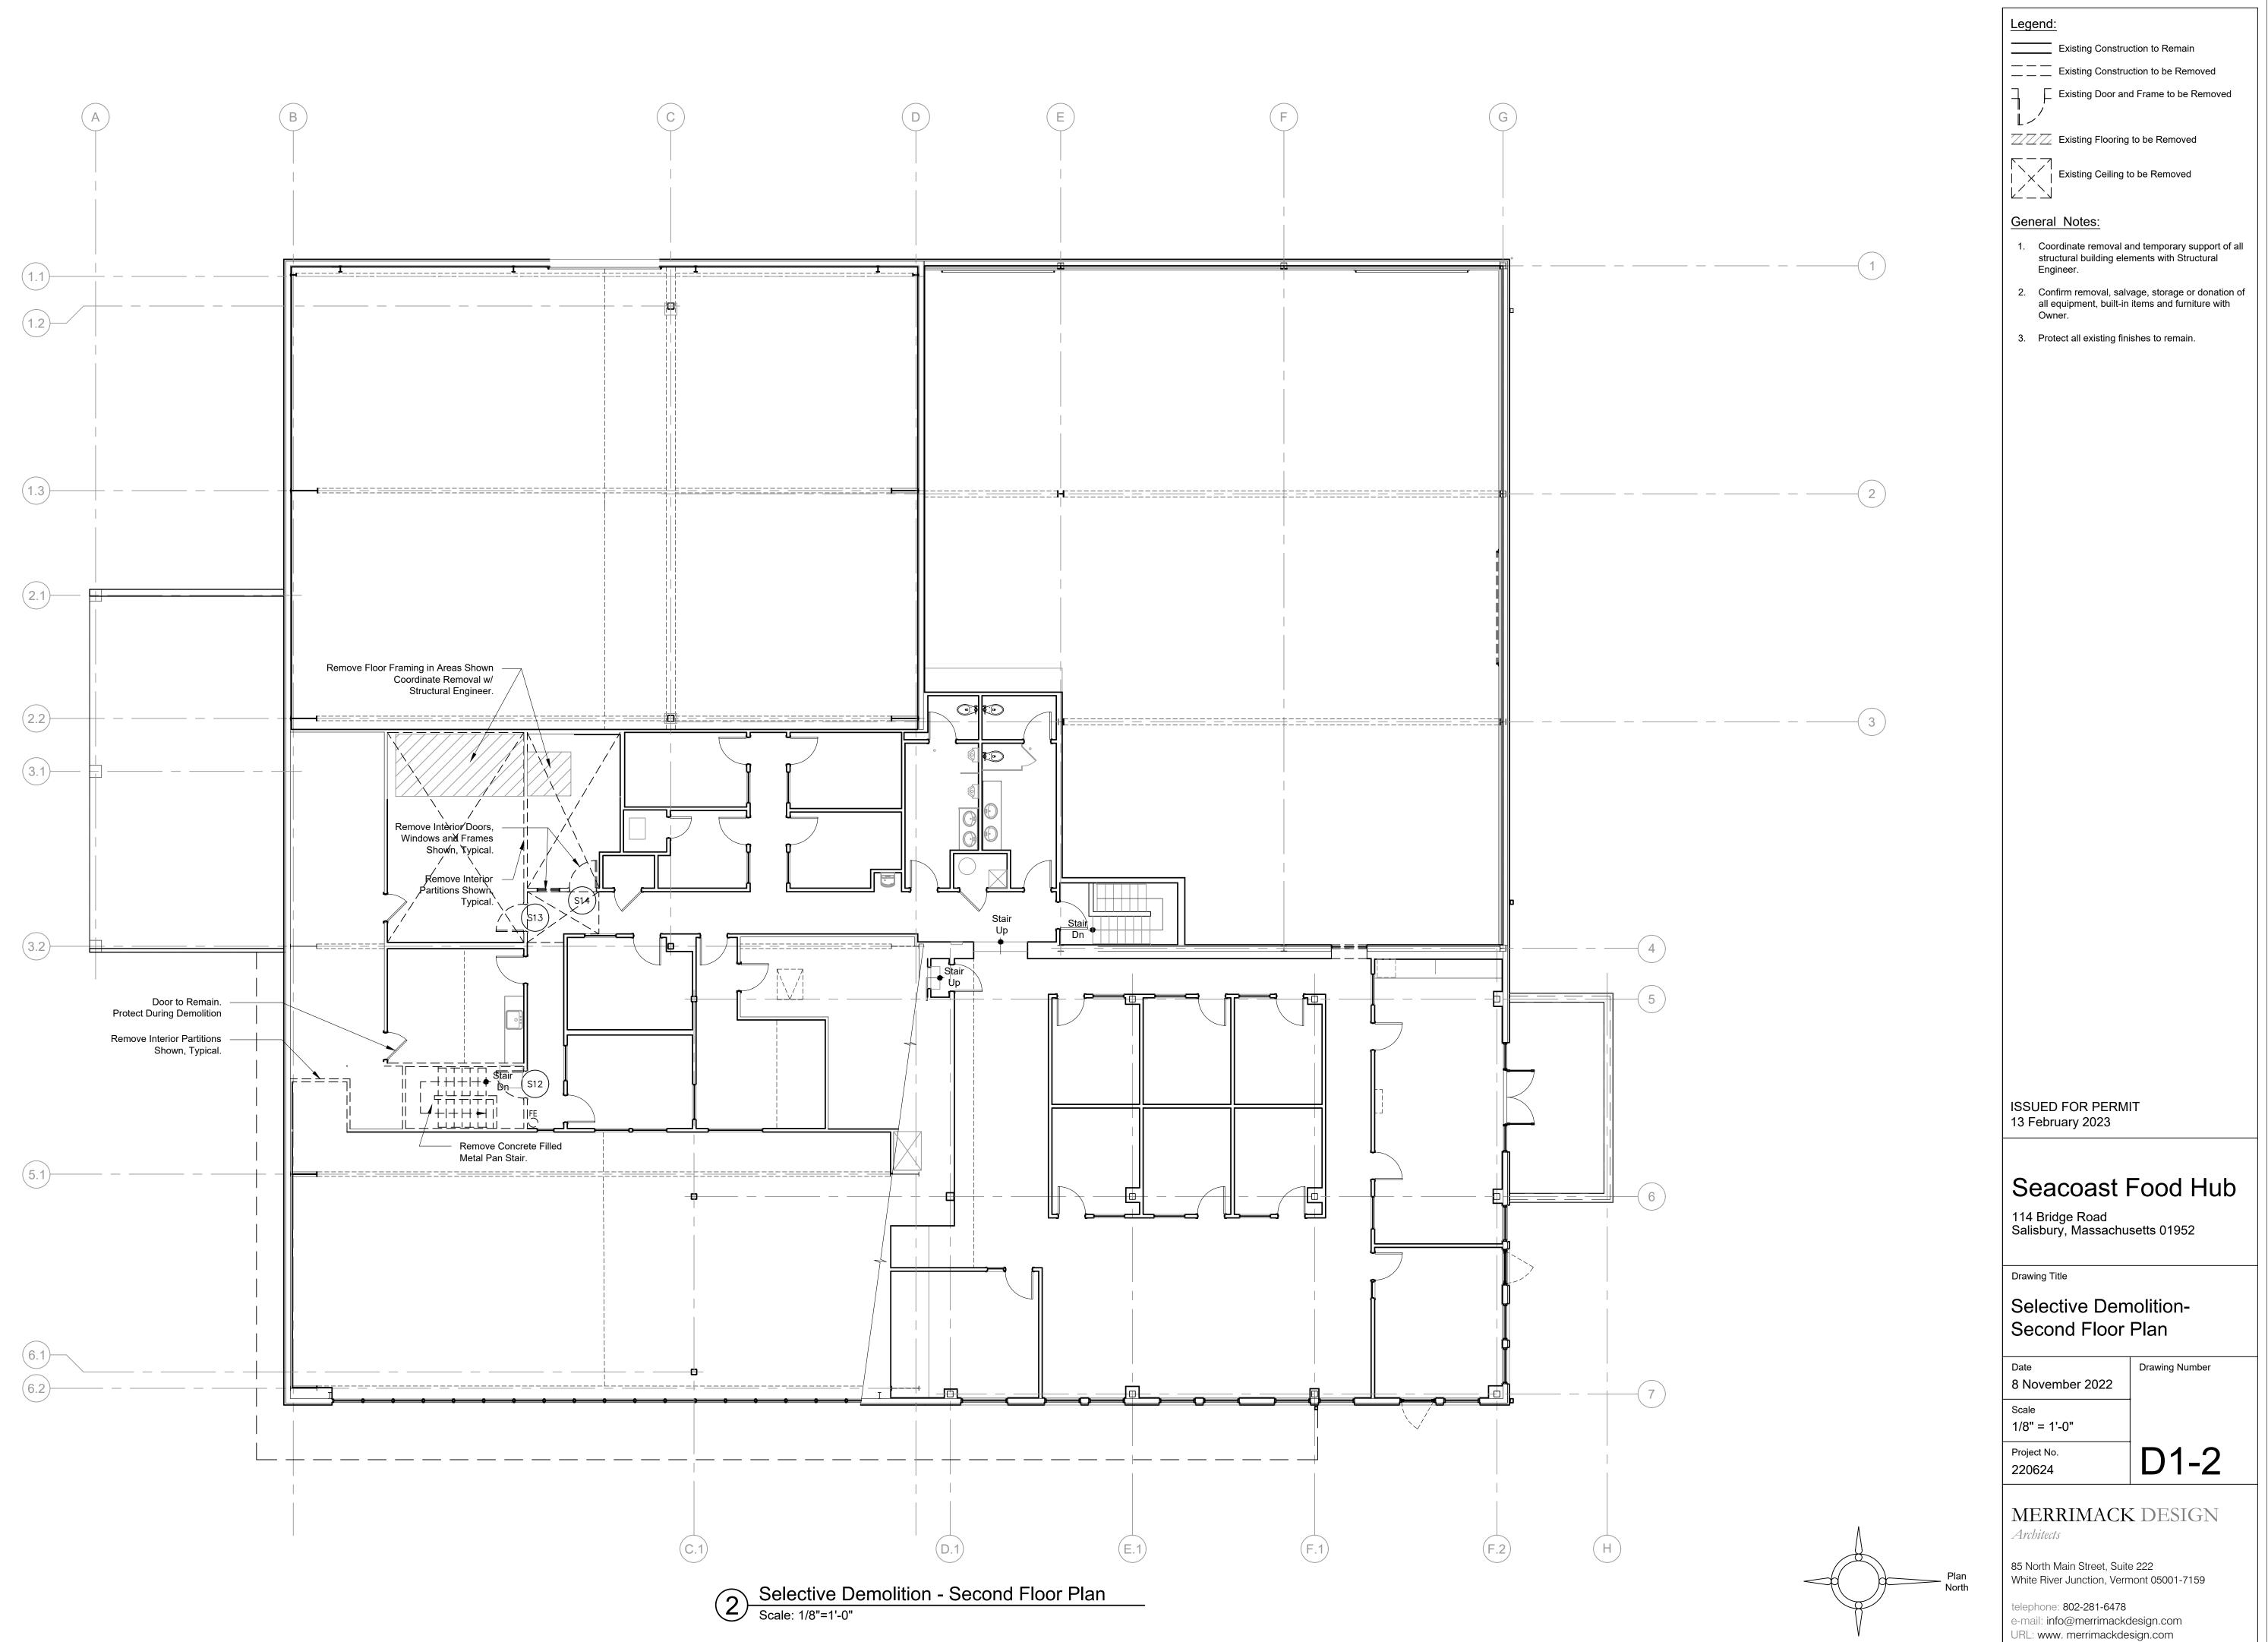
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Legend
Existing Wall Construction to Remain
Patch Existing Wall Construction at New Work New Furring on Existing Wall Construction
New Wood/Metal Frame Wall Construction
Wew Masonry Wall Construction
New Reinforced Concrete Wall Construction
○ FE Wall Mounted Portable Fire Extinguisher
General Notes
1. All Dimensions Shown are to Rough Framing Unless Noted Otherwise.
ISSUED FOR PERMIT
13 February 2023
Seacoast Food Hub
114 Bridge Road Salisbury, Massachusetts 01952
Drawing Title
Proposed Now Construction
Proposed New Construction
Second Floor Plan
Date Drawing Number
10 May 2022
Scale
1/8" = 1'-0"
Project No. 220624 A1-2
MEDDINGACK DESIGN
MERRIMACK DESIGN
1 II VIJUVVVJ
85 North Main Street, Suite 222 White River Junction, Vermont 05001-7159

telephone: 802-281-6478 e-mail: info@merrimackdesign.com URL: www. merrimackdesign.com  ${f \widehat{C}}$  MERRIMACK DESIGN *Architects* 

